

1. CONSTRUCTION OF THE SITE SHALL BE LIMITED TO WORKING HOURS SET FORTH BY SAN BERNARDINO COUNTY BUILDING DIVISION.
2. CONTRACTOR SHALL INSPECT THE JOB SITE AND STUDY ALL ELEMENTS OF WORKING DRAWINGS AND SPECIFICATIONS, AND REPORT ANY DISCREPANCIES TO ARCHITECT/DESIGNER PRIOR TO START OFF ANY WORK.
3. CONTRACTOR SHALL, AT THEIR OWN EXPENSE, CARRY ALL EMPLOYER'S LIABILITY INSURANCE AND PUBLIC LIABILITY INSURANCE NECESSARY FOR THE FULL PROTECTION OF THE CONTRACTOR AND OWNER DURING THE PROGRESS OF THE WORK. CONTRACTOR SHALL BE WHOLLY RESPONSIBLE IN CASE OF ANY LOSS OR DAMAGE TO ANY PERSON OR PROPERTY RESULTING FROM THE PERFORMANCE OF THIS CONTRACT AND AGREES TO HOLD THE OWNER HARMLESS FROM ALL LIABILITY AND EXPENSE RESULTING FROM CONSTRUCTION.
4. CONTRACTOR SHALL CONSULT WITH THE REPRESENTATIVES OF THE COUNTY, GAS, WATER, POWER, AND PHONE COMPANIES CONCERNING AVAILABLE FACILITIES BEFORE COMMENCING WORK OR CONNECTING FACILITIES.
5. CONTRACTOR SHALL GUARANTEE ALL WORKSMANSHIP AND MATERIALS FOR ONE YEAR AFTER PROJECT COMPLETION.
6. ALL CONTRACTORS DOING BUSINESS IN THE CITY SHALL HAVE A CERTIFICATE OF WORKER'S COMPENSATION ON FILE WITH THE COUNTY.
7. IT IS IMPORTANT FOR THE GENERAL CONTRACTOR TO UNDERSTAND THAT IT IS HIS/HER RESPONSIBILITY TO BE SURE THIS PROJECT IS CONSTRUCTED IN FULL COMPLIANCE WITH ALL STATE AND LOCAL CODES AND ORDINANCES. THE PLANS ARE NOT ALL INCLUSIVE OF ALL MINIMUM CODES AND ORDINANCES. THIS FACT DOES NOT RELIEVE THE CONTRACTOR FROM COMPLIANCE WITH ALL MINIMUM STANDARDS. NO OMISSION FROM THESE PLANS GIVES PERMISSION FOR VIOLATION OF ANY CODE OR ORDINANCE. NO APPROVAL EVER GRANTS TO VIOLATE ANY CODE OR COUNTY ORDINANCE.
8. THE GREATEST EFFORT HAS BEEN MADE TO DRAW THESE PLANS WITHOUT ERROR. HOWEVER, THERE IS NO GUARANTEE THAT THESE PLANS ARE WITHOUT ERROR. THE DESIGNER AND DRAFTSMAN ARE TO BE HELD HARMLESS ON ANY VIOLATION OF ANY CODE OR ORDINANCE FROM THESE PLANS. ANYONE USING THESE PLANS FOR CONSTRUCTION OF BUILDINGS ACCEPTS FULL RESPONSIBILITY.

A101	Title
A102	Site Plan
A103	General Notes
A201	Level 1
A202	Ceiling Plan
A203	Roof Plan
A301	Elevations
A401	Sections
A501	Door & Window Schedule
A601	Green Code
A602	Green Code
E000	Electrical General Notes
E100	First Floor Electrical
S001	General Notes CRC
S002	Minimum Nailing Schedule
S010	Foundation Plan
S020	First Floor Framing Plan
S030	Roof Framing Plan

PROJECT SCOPE:	PROJECT DATA:
CONSTRUCT A 500 SF ACCESSORY DWELLING UNIT. R-3 OCCUPANCY TYPE VB CONSTRUCTION	OWNER: LOT INFO: ADDRESS: A.P.N.: LEGAL:
DESIGN CRITERIA:	PROJECT INFO:
ROOF LL: 20 psf SNOW P _s : 30 psf WIND V ₅₀ : 150 mph Exposure C SEISMIC: Category D ₂	ADU: 560 SF BLDG. CODE DATA: OCCUPANCY GROUPS: R-3 TYPE OF CONSTRUCTION: V-B



PRIOR TO ANY CONSTRUCTION, CONTRACTOR SHALL MEET WITH OWNER OR OWNER'S REPRESENTATIVE

25. EVERY ITEM MENTIONED IN THE SPECIFICATIONS IS INTENDED TO REPRESENT

1. THESE PLANS WERE DESIGNED TO MEET THE MINIMUM REQUIREMENTS OF

- MEASUREMENTS:**

- SPECIFICATIONS AND DRAWINGS:**

1. ALL CONSTRUCTION MATERIALS AND WORKMANSHIP SHALL CONFORM TO

- any i
includ
out of
use o



County of San Bernardino
Building & Safety Division
385 N. Arrowhead Ave.
1st Floor
San Bernardino, CA 92415
909-387-8311
SBCounty.gov

All projects shall comply with the 2022 *California Building Code* (CBC) and/or *California Residential Code* (CRC), 2022 *California Green Building Standards Code* (CalGreen), 2022 *California Electrical Code* (CEC), 2022 *California Mechanical Code* (CMC), 2022 *California Plumbing Code* (CPC), 2022 *California Fire Code* (CFC), 2022 *California Building Energy Efficiency Standards* (CBEES), and all San Bernardino County amendments.

By using these standard plans, the user agrees to release San Bernardino County from any and all claims, liabilities, suits, and demands on account of any injury, damage, or loss to persons or property, including injury or death, or economic losses, arising out of the use of these construction documents. The use of these plans does not eliminate or reduce the user's responsibility to verify any and all information

Consultant
Address
Address
Phone
Fax
e-mail

Owner

Project number	Project Number
Date	Issue Date
Drawn by	Author
Checked by	Checker

A103


Sca

1. Reinforcement shall be solid lumber or other construction materials approved by the enforcing agency.
2. Reinforcement shall not be less than 2 by 8 inch nominal lumber [1½ inch by 7¼ inch actual dimension] or other construction material providing equal height and load capacity. Reinforcement shall be located between 32 inches and 39½ inches above the finished floor flush with the wall framing.
3. Water closet reinforcement shall be installed on both side walls of the fixture, or one side wall and the back wall.
4. Shower reinforcement shall be continuous where wall framing is provided.
5. Bathtub and combination bathtub/shower reinforcement shall be continuous on each end of the bathtub and the back wall. Additionally, back wall reinforcement for a lower grab bar shall be provided with the bottom edge located no more than 6 inches above the bathtub rim.

1. Where the water closet is not placed adjacent to a side wall capable of accommodating a grab bar, the bathroom shall have provisions for installation of floor-mounted, fixed or shower-stall alternate grab bar reinforcements approved by the enforcing agency.
2. Reinforcement shall not be required in wall framing for pre-fabricated shower enclosures and bathroom wall panels with integral factory-installed grab bars or when factory-installed reinforcement for grab bars is provided.
3. Shower enclosures that do not permit installation of reinforcement and/or grab bars shall be permitted, provided reinforcement for installation of floor-mounted grab bars or an alternate method is approved by the enforcing agency.
4. Bathrooms with no surrounding walls, or where the walls do not permit the installation of reinforcement shall be permitted, provided reinforcement for installation of floor-mounted grab bars adjacent to the bathtub or an alternate method is approved by the enforcing agency.
5. Reinforcement of the floor shall not be required for bathtubs and water closets installed on concrete slab floors.

1. Dedicated receptacle outlets; floor receptacle outlets; controls mounted on ceiling fans and ceiling lights; and controls located on appliances.
2. Receptacle outlets required by the California Electrical Code on a wall space where the distance between the finished floor and a built-in feature above the finish floor, such as a window, is less than 15 inches.

R327.1.4 Doorbell buttons. Doorbell buttons or controls, when installed, shall not exceed 48 inches above exterior floor or landing, measured from the top of the doorbell button assembly. Where doorbell buttons integrated with other features are required to be installed above 48 inches measured from the exterior floor or landing, a standard doorbell button or control shall also be provided at a height not exceeding 48 inches above exterior floor or landing, measured from the top of the doorbell button or control.

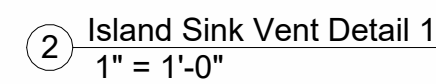

1. WALL FINISHED ON SHOWER AND WHIRLPOOL. TO BE TILED 70" MINIMUM HIGH ABOVE DRAIN INLET. CEMENT, FIBER-CEMENT, FIBER-MAT REINFORCED CEMENT, GLASS MAT GYPSUM OR FIBER REINFORCED GYPSUM BACKERS SHALL BE USED AS A BASE FOR WALL TITL IN TUB AND SHOWER AREAS AND WALL AND CEILING PANELS IN SHOWERS.
2. PROPOSED SHOWERS SHALL HAVE TEMPERED GLASS DOORS. DOORS SHALL SWING OUT.
3. SHOWER SIZE. SHOWER COMPARTMENTS SHALL HAVE MINIMUM AREA OF 1024 SQUARE INCHES AND BE ABLE TO ENCOMPASS A 30-INCH-DIAMETER CIRCLE. SHOWER DOORS SHALL HAVE A MINIMUM 22-INCH UNOBSTRUCTED WIDTH. (CPC 408.5 AND CPC 408.6)
4. A. WATER CLOSETS SHALL BE ULTRA LOW FLUSH WITH 1.28 GALS MAXIMUM PER FLUSH. B. SHOWERHEADS SHALL HAVE A MAXIMUM FLOW RATE OF 1.8 GALS PER MINUTE AT 80 PSI. C. LAVATORY FAUCETS SHALL NOT EXCEED 1.2 GALS PER MINUTE AT 80 PSI. D. KITCHEN FAUCETS SHALL NOT EXCEED 1.8 GALS PER MINUTE AT 80 PSI AND MAY TEMPORARILY INCREASE TO THE FLOW RATE ABOVE THE MAXIMUM RATE, BUT NOT TO EXCEED 2.2 GALS PER MINUTE AND MUST DEFAULT TO A MAXIMUM FLOW RATE OF 1.8 GALS PER MINUTE.
5. WATER CLOSET CLEARANCE. MINIMUM 30-INCH-WIDE BY 24-INCH-DEEP CLEARANCE REQUIRED AT FRONT OF WATER CLOSETS. (CPC 402.5)



All projects shall comply with the 2022 *California Building Code* (CBC) and/or *California Residential Code* (CRC), 2022 *California Green Building Standards Code* (CalGreen), 2022 *California Electrical Code* (CEC), 2022 *California Mechanical Code* (CMC), 2022 *California Plumbing Code* (CPC), 2022 *California Fire Code* (CFC), 2022 *California Building Energy Efficiency Standards* (CBEES), and all San Bernardino County amendments.

Consultant
Address
Address
Phone
Fax
e-mail

560 sf ADU

[illegible]

Owner

Level 1

Project number	Project Number
Date	Issue Date
Drawn by	Author
Checked by	Checker

A201

Scale	As indicated
-------	--------------

INTERIOR LIGHT SWITCHES & CONTROLS:

- ALL FORWARD PHASE CUT DIMMERS USED WITH LED LIGHT SOURCES SHALL COMPLY WITH NEMA SSL 7A.
- EXHAUST FANS SHALL BE SWITCHED SEPARATELY FROM LIGHTING SYSTEMS. LIGHTING INTEGRAL TO AN EXHAUST FAN MAY BE ON THE SAME SWITCH IF THE LIGHT CAN BE SWITCHED OFF IN ACCORDANCE WITH SECTION 150.0(k)2 WHILE THE FAN CONTINUES TO OPERATE.
- LUMINAIRES SHALL BE SWITCHED WITH ACCESSIBLE CONTROLS THAT PERMIT THE LUMINAIRES TO BE MANUALLY SWITCHED ON & OFF.
- LIGHTING CONTROLS & EQUIPMENT SHALL BE INSTALLED IN ACCORDANCE WITH MFR'S INSTRUCTIONS.
- CONTROLS SHALL NOT BYPASS A DIMMER OR VACANCY SENSOR FUNCTIONS THAT COMPLY WITH SECTION 150.0(k).
- LIGHTING CONTROLS SHALL COMPLY WITH THE APPLICABLE REQUIREMENTS OF SECTION 110.9.
- AN ENERGY MANAGEMENT CONTROL SYSTEM (EMCS) MAY BE USED TO COMPLY WITH DIMMER OR VACANCY SENSOR REQUIREMENTS IF AT A MINIMUM IT PROVIDES THE FUNCTIONALITY OF A DIMMER IN ACCORDANCE WITH SECTION 110.9, MEETS THE INSTALLATION CERTIFICATE REQUIREMENTS IN SECTION 130.4, THE EMCS REQUIREMENTS IN SECTION 130.5(F), AND COMPLIES WITH ALL OTHER APPLICABLE REQUIREMENTS IN SECTION 150.0(k)2. A MULTISCENE PROGRAMMABLE CONTROLLER MAY ALSO BE USED TO COMPLY WITH DIMMER REQUIREMENTS.
- IN BATHROOMS, GARAGES, LAUNDRY ROOMS, AND UTILITY ROOMS, AT LEAST ONE LUMINAIRE IN EACH OF THESE SPACES SHALL BE CONTROLLED BY A VACANCY SENSOR.
- DIMMERS OR VACANCY SENSORS SHALL CONTROL ALL LUMINAIRES REQUIRED TO HAVE LIGHT SOURCES COMPLIANT WITH REFERENCE JOINT APPENDIX JA8 EXCEPT IN CLOSETS LESS THAN 70 SQ. FT. & HALLWAYS.
- UNDER CABINET LIGHTING SHALL BE SWITCHED SEPARATELY FROM OTHER LIGHTING SYSTEMS.

OUTDOOR LIGHTING:

- IN ADDITION TO MEETING THE REQUIREMENTS OF SECTION 150.0(k)1A, OUTDOOR LUMINAIRES SHALL:
BE CONTROLLED BY A MANUAL 'ON & OFF' SWITCH THAT DOES NOT OVERRIDE AUTOMATIC FUNCTIONS AND ONE OF THE FOLLOWING DEVICES:
PHOTOCELL & MOTION SENSOR. CONTROLS THAT OVERRIDE TO 'ON' SHALL BE ALLOWED IF THE OVERRIDE AUTOMATICALLY REACTIVATES THE MOTION SENSOR WITHIN 6 HOURS;
OR:
PHOTOCONTROL & AUTOMATIC TIME SWITCH CONTROL. CONTROLS THAT OVERRIDE TO 'ON' SHALL BE ALLOWED IF THE OVERRIDE AUTOMATICALLY RETURNS THE PHOTOCONTROL & AUTOMATIC TIME SWITCH CONTROL TO ITS NORMAL OPERATION WITHIN 6 HOURS.
- ASTRONOMICAL TIME CLOCK. CONTROLS THAT OVERRIDE TO 'ON' SHALL BE ALLOWED IF THE OVERRIDE AUTOMATICALLY RETURNS THE ASTRONOMICAL CLOCK TO ITS NORMAL OPERATION WITHIN 6 HOURS AND IT IS PROGRAMMED TO AUTOMATICALLY TURN THE OUTDOOR LIGHTING 'OFF' DURING DAYLIGHT HOURS.
- ENERGY MANAGEMENT CONTROL SYSTEM. AT A MINIMUM PROVIDES THE FUNCTIONALITY OF AN ASTRONOMICAL TIME CLOCK IN ACCORDANCE WITH SECTION 110.9, MEETS THE INSTALLATION CERTIFICATION REQUIREMENTS IN SECTION 130.4, DOES NOT HAVE AN OVERRIDE OR BYPASS SWITCH THAT ALLOWS THE LUMINAIRE TO BE ALWAYS 'ON', AND IS PROGRAMMED TO AUTOMATICALLY TURN THE OUTDOOR LIGHTING 'OFF' DURING DAYLIGHT HOURS.

INTERNALLY ILLUMINATED ADDRESS

- INTERNALLY ILLUMINATED ADDRESS SIGNS SHALL COMPLY WITH SECTION 140.8 UNLESS THEY CONSUME LESS THAN 5 WATTS OF POWER AS DETERMINED ACCORDING TO SECTION 130.0(c).

ELECTRICAL NOTES:

- LOCAL UTILITY COMPANY APPROVAL IS REQUIRED FOR METER LOCATION PRIOR TO INSTALLATION.
- BRANCH CIRCUITS SUPPLYING RECEPTACLES IN KITCHENS (EXCEPT THOSE REQUIRED TO BE GFCI WHERE SERVING COUNTERTOPS), FAMILY ROOMS, DINING ROOMS, LIVING ROOMS, PARLORS, LIBRARIES, DENS, BEDROOMS, SUNROOMS, RECREATION ROOMS, CLOSETS, HALLWAYS, LAUNDRY AND SIMILAR ROOMS OR AREAS SHALL BE PROTECTED BY A LISTED ARC-FAULT CIRCUIT INTERRUPTER (AFCI).
- ALL RECEPTACLES LOCATED IN BATHROOMS, KITCHENS, LAUNDRY, UTILITY, WET BARS, GARAGES, ACCESSORY BUILDINGS, & OUTDOORS SHALL HAVE GROUND-FAULT CIRCUIT-INTERRUPTER (GFCI) PROTECTION.
- PROVIDE GROUNDING W/20' UFER BAR IN FOOTING. - BOND TO GAS AND WATER LINES.
- BATHROOM RECEPTACLES TO BE ON AN ISOLATED 20 AMP CIRCUIT.
- PROVIDE IWO (2) 20 AMP SMALL-APPLIANCE CIRCUITS IN KITCHEN AND ONE (1) 20 AMP LAUNDRY CIRCUIT.
- PROVIDE LOW VOLTAGE LIGHTED ADDRESS SIGN. - NUMBERS SHALL BE OF NON-COMBUSTIBLE MATERIALS IN SPECIAL FIRE OVERLAY AREAS.
- SINGLE FAMILY RESIDENTIAL ADDRESS NUMBERS SHALL BE CONTRASTING ILLUMINATED AND ALIGNED HORIZONTALLY. - THE NUMBERS SHALL BE 4" HIGH WHEN UP TO 50 FT. FROM CURB LINE, 6" UP TO 100 FT. AND 8" IF OVER 100 FT. NOTE- IF NO CURB, THE DISTANCE SHALL BE MEASURED FROM THE PROPERTY LINE.
- CENTRAL HEATING EQUIPMENT REQUIRES AN INDIVIDUAL BRANCH CIRCUIT.
- ALL FIXTURE LOCATIONS ARE DIAGRAMMATIC. - EXACT TYPE AND LOCATION TO BE SPECIFIED BY OWNER.
- PROVIDE RECEPTACLES ON THE OUTSIDE OF THE BUILDING (FRONT AND BACK) AND IN THE ATTACHED GARAGE.
- ALL OUTSIDE RECEPTACLES SHALL HAVE AN "IN-USE" ENCLOSURE.
- PROVIDE DOUBLE SWITCHING AND SOLID BLOCKING AND METAL BOXES AT ALL CEILING FANS.
- PROVIDE RECEPTACLE AT ANY WALL 2' OR MORE, AND EVERY 12'.
- PROVIDE AT LEAST ONE (1) RECEPTACLE AT HALLWAYS OF 10' OR MORE IN LENGTH.
- BRACE ALL OVERHEAD BEDROOM LIGHTS BETWEEN TRUSSES FOR POSSIBILITY OF FUTURE CEILING FAN (USE "UL" APPROVED FAN OUTLET BOXES).
- GARAGE AND KITCHEN RECEPTACLES TO BE 4' 42" A.F.F. (UNLESS NOTED OTHERWISE).
- IN KITCHENS AND DINING AREAS, RECEPTACLES SHALL BE INSTALLED EVERY 4' ALONG THE WALL LINE OF COUNTER SPACES 12" OR WIDER.
- ISLAND AND PENINSULA COUNTER TOPS 12" OR WIDER SHALL HAVE ONE (1) RECEPTACLE FOR EACH 4' OF COUNTER SPACE.
- SMOKE DETECTOR TO BE HARD WIRED. % BATTERY BACKUP AND TO BE WITHIN 12" OF CEILING. SMOKE DETECTORS SHALL BE INTER-CONNECTED AND SOUND SIMULTANEOUSLY.
- PROVIDE ONE LIGHT CIRCUIT FOR EACH 500 S.F. OF LIVEABLE AREA.
- IF LIGHT IN CLOSET IS LESS THAN 12" TO COMBUSTIBLES, PROVIDE RECESSED LIGHT.
- A/C UNIT SHALL BE F.A.U. LOCATED IN ATTIC. - PROVIDE RECEPTACLE AND LIGHT % SWITCH AT ATTIC ACCESS.
- PRIMARY LIGHTING AT ALL BATHS AND KITCHEN SHALL BE HIGH EFFICACY.
- PROVIDE WEATHER RESISTIVE G.F.I.C. DUPLEX RECEPTACLE WITHIN 25 FT. OF ANY ELECTRICAL EQUIPMENT w/ 30 AMP OR GREATER LOAD.
- BOND ALL GAS AND WATER PIPES.
- PROVIDE 3'-0" (MIN.) CLEAR WORK SPACE AT MAIN PANEL.
- NON-METALLIC SHEATHED CABLE SHALL BE CONCEALED OR PROTECTED.
- PROVIDE CARBON MONOXIDE ALARM AS SHOWN AND INSTALLED PER THE CALIFORNIA RESIDENTIAL CODE AND MANUFACTURER SPECIFICATIONS.
- ALL ELECTRICAL OUTLETS SHALL BE TAMPER RESISTANT (CHILD PROOF) TYPE..
- RECEPTACLE @ GARBAGE DISPOSAL SHALL BE ON SEPARATE #12 A.W.G. WIRE BRANCH CIRCUIT.
- BATHROOM SHALL BE MECHANICALLY VENTED AND BE ENERGY STAR COMPLIANT, CONTROLLED BY A HUMIDITY CONTROL, CAPABLE OF MANUAL OR AUTOMATICALLY ADJUSTMENT OF RELATIVE HUMIDITY BETWEEN ≤ 50 PERCENT TO A MAXIMUM OF 80 PERCENT. EXHAUST FANS SHALL BE CAPABLE OF PROVIDING A MINIMUM OF 50 CFM INTERMITTENTLY OR 20 CFM CONTINUOUS VENTILATION.



www.sbcounty.gov

County of San Bernardino
Building & Safety Division
385 N. Arrowhead Ave.
1st Floor
San Bernardino, CA 92415
909-387-8311
SBCounty.gov


All projects shall comply with the 2022 California Building Code (CBC) and/or California Residential Code (CRC), 2022 California Green Building Standards Code (CalGreen), 2022 California Electrical Code (CEC), 2022 California Mechanical Code (CMC), 2022 California Plumbing Code (CPC), 2022 California Fire Code (CFC), 2022 California Building Energy Efficiency Standards (CBEES), and all San Bernardino County amendments.

By using these standard plans, the user agrees to release San Bernardino County from any and all claims, liabilities, suits, and demands on account of any injury, damage, or loss to persons or property, including injury or death, or economic losses, arising out of the use of these construction documents. The use of these plans does not eliminate or reduce the user's responsibility to verify any and all information

Consultant
Address
Address
Phone
Fax
e-mail

560 sf ADU

ELECTRICAL LEGEND:		MECHANICAL LEGEND:	
	110V DUPLEX RECEPTACLE		CARBON MONOXIDE / SMOKE ALARM
	SERVICE RECEPTACLE		GARBAGE DISPOSAL
	ARC FAULT RECEPTACLE		GARAGE DOOR OPENER
	110V GFI DUPLEX RECEPTACLE (GROUND FAULT)		ATTIC ACCESS
	110V WATER-PROOF DUPLEX RECEPTACLE		EXHAUST FAN
	HALF HOT		UP DUCT
	220V RECEPTACLE		RETURN AIR
	220V RANGE RECEPTACLE		SUPPLY AIR
	COMMON WALL SWITCH		ATTIC FURNACE
	3-WAY WALL SWITCH		ROOF MOUNTED A/C UNIT
	MOTION LIGHTING		GROUND MOUNTED A/C UNIT
	PHOTOCELL		WALL MOUNTED MASTER COOL
	TELEVISION OUTLET		
	TELEPHONE OUTLET		
LIGHTING LEGEND:			
	6" DIA. RECESSED CAN LIGHT FIXTURE		
	VANITY WALL MOUNTED LIGHTING FIXTURE		
	4" FINISH TYPE 2 TUBE FLUORESCENT		
ACCESSORY LEGEND:			
	HOSE BIB W/WATERING SYSTEM STUB-OUT		
	MEDICINE CABINET		
	CEILING LIGHT, FANS & FANS w/LIGHT		

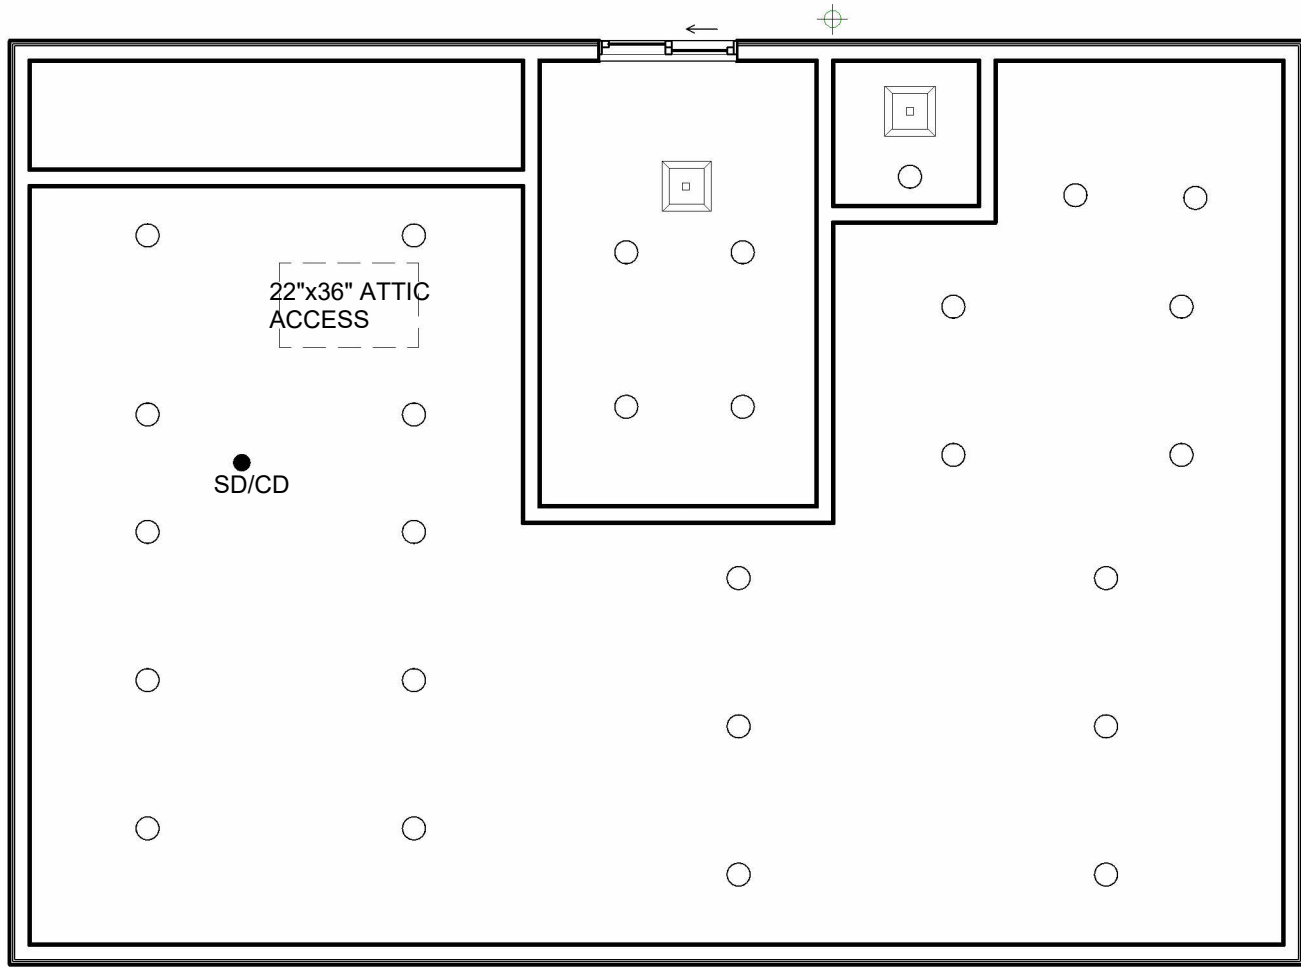

1 Level 1
1/4" = 1'-0"

Owner


Ceiling Plan

Project number	Project Number
Date	Issue Date
Drawn by	Author
Checked by	Checker

A202

Scale	As indicated
-------	--------------

7/8/2025 7:55:42 AM

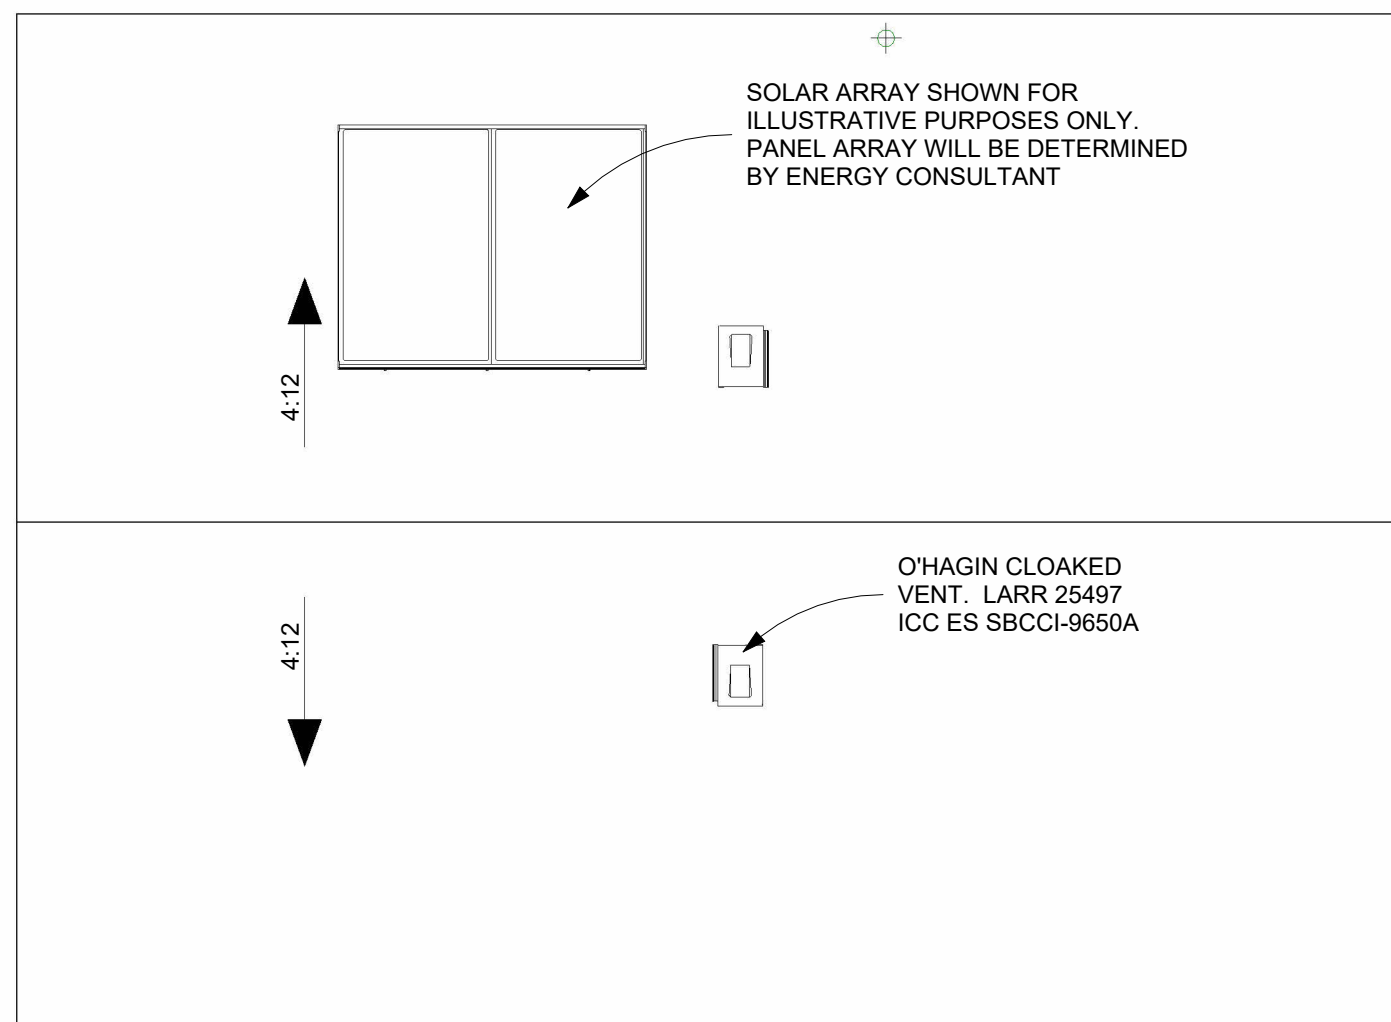

O'HAGIN CLOAKED
VENT. LARR 25497
ICC ES SBCCI-9650A

1 Roof
1/4" = 1'-0"

FIRE SAFETY OVERLAY NOTES:

EXPOSED ROOF DECK ON THE UNDERSIDE OF UNENCLOSED ROOF EAVES SHALL CONSIST OF ONE OF THE FOLLOWING:

- A. NONCOMBUSTIBLE MATERIAL OR
- B. IGNITION-RESISTANT MATERIAL OR
- C. ONE LAYER OF 5/8" TYPE X APPLIED BEHIND AN EXTERIOR COVERING ON THE UNDERSIDE EXTERIOR OF ROOF DECK OR
- D. EXTERIOR PORTION OF A 1-HR FIRE RESISTIVE EXTERIOR WALL ASSEMBLY APPLIED TO THE UNDERSIDE OF ROOF DECK DESIGNED FOR EXTERIOR FIRE EXPOSURE PER GYPSUM ASSOCIATION FIRE RESISTANCE DESIGN MANUAL.

EXPOSED UNDERSIDE SHALL BE PROTECTED BY ONE OF THE FOLLOWING:

- | | |
|----|---|
| A. | NONCOMBUSTIBLE MATERIAL OR |
| B. | IGNITION-RESISTANT MATERIAL OR |
| C. | ONE LAYER OF $\frac{5}{8}$ " TYPE X APPLIED BEHIND AN EXTERIOR COVERING ON THE UNDERSIDE OF THE RAFTER TAILS OR SOFFIT OR |
| D. | EXTERIOR PORTION OF A 1-HR FIRE RESISTIVE EXTERIOR WALL ASSEMBLY APPLIED TO THE UNDERSIDE OF RAFTER TAILS OR SOFFIT PER GYPSUM ASSOCIATION FIRE RESISTANCE DESIGN MANUAL OR |
| E. | BOXED-IN ROOF EAVE SOFFIT ASSEMBLIES COMPLYING WITH SFM 12-7.3-3 OR ASTM E2957. |

EXPOSED UNDERSIDE SHALL BE PROTECTED BY ONE OF THE FOLLOWING:

- A. NONCOMBUSTIBLE MATERIAL OR
- B. IGNITION-RESISTANT MATERIAL OR
- C. ONE LAYER OF 5/8" TYPE X APPLIED BEHIND AN EXTERIOR COVERING ON THE UNDERSIDE OF THE CEILING OR
- D. EXTERIOR PORTION OF A 1-HR FIRE RESISTIVE EXTERIOR WALL ASSEMBLY APPLIED TO THE UNDERSIDE OF THE CEILING ASSEMBLY PER GYPSUM ASSOCIATION FIRE RESISTANCE DESIGN MANUAL OR
- E. PORCH CEILING ASSEMBLIES WITH A HORIZONTAL UNDERSIDE COMPLYING WITH SFM 12-7A-3 OR ASTM E2957.

ROOF COVERING:

1. ALL ROOF COVERING SHALL BE INSTALLED PER APPLICABLE REQUIREMENTS OF CBC. ROOF COVERINGS SHALL BE AT LEAST CLASS A RATED IN ACCORDANCE WITH ASTM E 108 OR UL 790, WHICH SHALL INCLUDE COVERINGS OF SLATE, CLAY OR CONCRETE ROOF TILE EXPOSED CONCRETE ROOF DECK, FERROUS OR COPPER SHINGLES OR SHEETS.
2. **ROOF FLASHING.** FLASHING SHALL BE INSTALLED AT WALL AND ROOF INTERSECTIONS. AT GUTTERS, WHEREVER THERE IS A CHANGE IN ROOF SLOPE OR DIRECTION, AND AROUND ROOF OPENINGS. WHERE FLASHING IS OF METAL, THE METAL SHALL BE CORROSION-RESISTANT WITH A THICKNESS OF NOT LESS THAN 0.019 INCH (NO. 26 GALVANIZED SHEET).
3. **CRICKETS AND SADDLES.** A CRICKET OR SADDLE SHALL BE INSTALLED ON THE RIDGE SIDE OF ANY CHIMNEY OR PENETRATION MORE THAN 30 INCHES WIDE AS MEASURED PERPENDICULAR TO THE ROOF SLOPE. CRICKET OR SADDLE COVERING SHALL BE SHEET METAL OR THE SAME MATERIAL AS THE ROOF COVERING.

ROOF AREA

VENT REQUIRED: $\frac{560 \text{ Sq.Ft.}}{150} = 3.733 \times 144 = 537 \text{ Sq.In.}$

VENT PROVIDED:

2 - GALV. STEEL LOUVERED VENT DECORATIVE VENT (264 sq. in.)

2 - O' HAGIN ROOF COMPOSITION VENT MODEL "FLAT" (72 sq. in.)

$$528 + 144 = \underline{672} \text{ sq. in.}$$

ATTIC VENT CALCULATION

VENT OPENINGS SHALL COMPLY WITH ONE OF THE FOLLOWING:

- a. LISTED VENT COMPLYING WITH ASTM E2886 OR
b. PROTECTED BY CORROSION RESISTANT, NONCOMBUSTIBLE
WIRE MESH WITH MINIMUM 1/16" AND MAXIMUM 1/8" OPENINGS
c. LARR 25495, LEGACY REPORT ICC ES SBCCI-9650A



www.sbcounty.gov

County of San Bernardino
Building & Safety Division
385 N. Arrowhead Ave.
1st Floor
San Bernardino, CA 92415
909-387-8311
SBCounty.gov

All projects shall comply with the 2022 California Building Code (CBC) and/or California Residential Code (CRC), 2022 California Green Building Standards Code (CalGreen), 2022 California Electrical Code (CEC), 2022 California Mechanical Code (CMC), 2022 California Plumbing Code (CPC), 2022 California Fire Code (CFC), 2022 California Building Energy Efficiency Standards (CBEES), and all San Bernardino County amendments.

By using these standard plans, the user agrees to release San Bernardino County from any and all claims, liabilities, suits, and demands on account of any injury, damage, or loss to persons or property, including injury or death, or economic losses, arising out of the use of these construction documents. The use of these plans does not eliminate or reduce the user's responsibility to verify any and all information

Consultant
Address
Address
Phone
Fax
e-mail

560 sf ADU

[illegible]

Owner

Roof Plan

Project number	Project Number
Date	Issue Date
Drawn by	Author
Checked by	Checker
A203	
Scale	1/4" = 1'-0"



County of San Bernardino
Building & Safety Division
385 N. Arrowhead Ave.
1st Floor
San Bernardino, CA 92415
909-387-8311
SBCounty.gov

All projects shall comply with the 2022 *California Building Code* (CBC) and/or *California Residential Code* (CRC), 2022 *California Green Building Standards Code* (CalGreen), 2022 *California Electrical Code* (CEC), 2022 *California Mechanical Code* (CMC), 2022 *California Plumbing Code* (CPC), 2022 *California Fire Code* (CFC), 2022 *California Building Energy Efficiency Standards* (CBEES), and all San Bernardino County amendments.

By using these standard plans, the user agrees to release San Bernardino County from any and all claims, liabilities, suits, and demands on account of any injury, damage, or loss to persons or property, including injury or death, or economic losses, arising out of the use of these construction documents. The use of these plans does not eliminate or reduce the user's responsibility to verify any and all information

Consultant
Address
Address
Phone
Fax
e-mail

560 sf ADU

[illegible]





Owner





Elevations

Project number	Project Number
Date	Issue Date
Drawn by	Author
Checked by	Checker

A301

Scale $1/4" = 1'-0"$

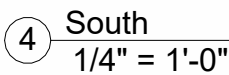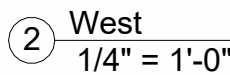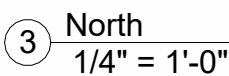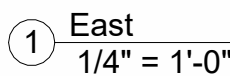

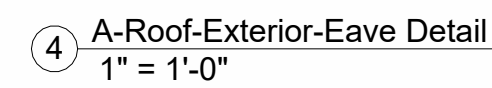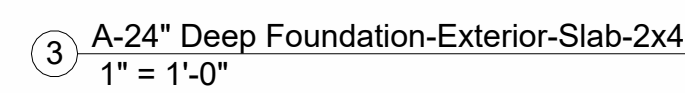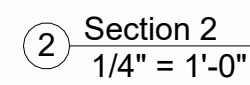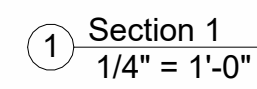



County of San Bernardino
Building & Safety Division
385 N. Arrowhead Ave.
1st Floor
San Bernardino, CA 92415
909-387-8311
SBCounty.gov

All projects shall comply with the 2022 *California Building Code (CBC)* and/or *California Residential Code (CRC)*, 2022 *California Green Building Standards Code (CalGreen)*, 2022 *California Electrical Code (CEC)*, 2022 *California Mechanical Code (CMC)*, 2022 *California Plumbing Code (CPC)*, 2022 *California Fire Code (CFC)*, 2022 *California Building Energy Efficiency Standards (CBEES)*, and all San Bernardino County amendments.

By using these standard plans, the user agrees to release San Bernardino County from any and all claims, liabilities, suits, and demands on account of any injury, damage, or loss to persons or property, including injury or death, or economic losses, arising out of the use of these construction documents. The use of these plans does not eliminate or reduce the user's responsibility to verify any and all information

Consultant
Address
Address
Phone
Fax
e-mail

560 sf ADU

[illegible]

Owner	
Door & Window Schedule	
Project number	Project Number
Date	Issue Date
Drawn by	Author
Checked by	Checker
A501	
Scale	

Owner

Door & Window Schedule

Project number	Project Number
----------------	----------------

Date	Issue Date
------	------------

Drawn by	Author
----------	--------

Checked by	Checker
------------	---------

A501

Scale

Door Schedule							
Mark	Width	Height	Thickness	Type	Rough Width	Rough Height	Comments
1	3' - 0"	6' - 8"	0' - 1 1/2"	36" x 80"	3' - 2"	6' - 9"	
2	3' - 0"	6' - 8"	0' - 2"	36" x 80"			
3	6' - 0"	6' - 8"	0' - 1 1/2"	72" x 80"	6' - 2"	6' - 9"	
4	3' - 0"	6' - 8"	0' - 1"	36"x80"			Louvered door with a minimum 100 square inch opening for makeup air

Window Schedule						
Type Mark	Width	Height	Head Height	Sill Height	Type	Comments
A	4' - 0"	4' - 0"	6' - 8"	2' - 8"	48" x 48"	SEE ENERGY CALCULATIONS FOR REQUIRED u VALUE AND SHGC VALUE
A	4' - 0"	4' - 0"	6' - 8"	2' - 8"	48" x 48"	SEE ENERGY CALCULATIONS FOR REQUIRED u VALUE AND SHGC VALUE
A	4' - 0"	4' - 0"	6' - 8"	2' - 8"	48" x 48"	SEE ENERGY CALCULATIONS FOR REQUIRED u VALUE AND SHGC VALUE
A	4' - 0"	4' - 0"	6' - 8"	2' - 8"	48" x 48"	SEE ENERGY CALCULATIONS FOR REQUIRED u VALUE AND SHGC VALUE
B	3' - 0"	3' - 0"	6' - 8"	3' - 8"	36" x 36"	SEE ENERGY CALCULATIONS FOR REQUIRED u VALUE AND SHGC VALUE
C	3' - 0"	1' - 0"	7' - 6 1/2"	6' - 6 1/2"	36" x 12"	SEE ENERGY CALCULATIONS FOR REQUIRED u VALUE AND SHGC VALUE

[illegible]



(January 2023)



All projects shall comply with the 2022 California Building Code (CBC) and/or California Residential Code (CRC), 2022 California Green Building Standards Code (CalGreen), 2022 California Electrical Code (CEC), 2022 California Mechanical Code (CMC), 2022 California Plumbing Code (CPC), 2022 California Fire Code (CFC), 2022 California Building Energy Efficiency Standards (CBEES), and all San Bernardino County amendments.

Consultant
Address
Address
Phone
Fax
e-mail

560 sf ADU

Owner

Green Code

A601

7/8/2025 7:56:10 AM

DISCLAIMER: THIS DOCUMENT IS PROVIDED AND INTENDED TO BE USED AS A MEANS TO INDICATE AREAS OF COMPLIANCE WITH THE CALIFORNIA GREEN BUILDING STANDARDS (CALGREEN) CODE. DUE TO THE VARIABLES BETWEEN BUILDING DEPARTMENT JURISDICTIONS, THIS CHECKLIST IS TO BE USED ON AN INDIVIDUAL PROJECT BASIS AND MAY BE MODIFIED BY THE END USER TO MEET THOSE INDIVIDUAL NEEDS. THE END USER ASSUMES ALL RESPONSIBILITY ASSOCIATED WITH THE USE OF THIS DOCUMENT, INCLUDING VERIFICATION WITH THE FULL CODEBOOK.



County of San Bernardino
Building & Safety Division
385 N. Arrowhead Ave.
1st Floor
San Bernardino, CA 92415
909-387-8311
SBCounty.gov

All projects shall comply with the 2022 *California Building Code* (CBC) and/or *California Residential Code* (CRC), 2022 *California Green Building Standards Code* (CalGreen), 2022 *California Electrical Code* (CEC), 2022 *California Mechanical Code* (CMC), 2022 *California Plumbing Code* (CPC), 2022 *California Fire Code* (CFC), 2022 *California Building Energy Efficiency Standards* (CBEES), and all San Bernardino County amendments.

By using these standard plans, the user agrees to release San Bernardino County from any and all claims, liabilities, suits, and demands on account of any injury, damage, or loss to persons or property, including injury or death, or economic losses, arising out of the use of these construction documents. The use of these plans does not eliminate or reduce the user's responsibility to verify any and all information

Consultant
Address
Address
Phone
Fax
e-mail

560 sf ADU

[illegible]

Owner



Minimum Nailing Schedule

Project number	Project Number
Date	Issue Date
Drawn by	Author
Checked by	Checker


S002

Scale



[illegible]

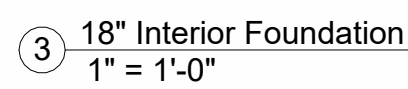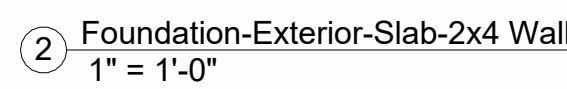


Walkways and landings to have a max. slope of 2%.

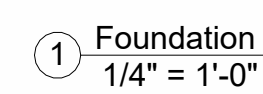

Scale	As indicated
-------	--------------

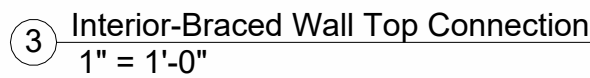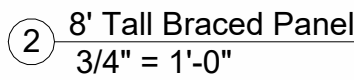

1. WOOD STRUCTURAL PANELS SHALL CONFORM TO DOC PS 1, DOC PS 2 OR ANSI/APA PRP 210, CSA Q437 OR CSA Q325.
2. PANELS SHALL BE IDENTIFIED BY A GRADE MARK OR CERTIFICATE OF INSPECTION ISSUED BY AN APPROVED AGENCY
3. VERTICAL JOINTS OF PANEL SHEATHING SHALL OCCUR OVER AND BE FASTENED TO COMMON STUDS.
4. HORIZONTAL JOINTS IN STRUCTURAL WALL PANELS SHALL OCCUR OVER AND BE FASTENED TO COMMON BLOCKING OF A MINIMUM 1 1/2 INCH THICKNESS.

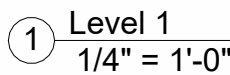

County of San Bernardino
Building & Safety Division
385 N. Arrowhead Ave.
1st Floor
San Bernardino, CA 92415
909-387-8311
SBCounty.gov

All projects shall comply with the 2022 *California Building Code (CBC)* and/or *California Residential Code (CRC)*, 2022 *California Green Building Standards Code (CalGreen)*, 2022 *California Electrical Code (CEC)*, 2022 *California Mechanical Code (CMC)*, 2022 *California Plumbing Code (CPC)*, 2022 *California Fire Code (CFC)*, 2022 *California Building Energy Efficiency Standards (CBEES)*, and all San Bernardino County amendments.

By using these standard plans, the user agrees to release San Bernardino County from any and all claims, liabilities, suits, and demands on account of any injury, damage, or loss to persons or property, including injury or death, or economic losses, arising out of the use of these construction documents. The use of these plans does not eliminate or reduce the user's responsibility to verify any and all information

Consultant
Address
Address
Phone
Fax
e-mail

560 sf ADU

Owner

First Floor Framing Plan

Project number	Project Number
Date	Issue Date
Drawn by	Author
Checked by	Checker

S020

Scale	As indicated
-------	--------------



County of San Bernardino
Building & Safety Division
385 N. Arrowhead Ave.
1st Floor
San Bernardino, CA 92415
909-387-8311
SBCounty.gov

All projects shall comply with the 2022 *California Building Code (CBC)* and/or *California Residential Code (CRC)*, 2022 *California Green Building Standards Code (CalGreen)*, 2022 *California Electrical Code (CEC)*, 2022 *California Mechanical Code (CMC)*, 2022 *California Plumbing Code (CPC)*, 2022 *California Fire Code (CFC)*, 2022 *California Building Energy Efficiency Standards (CBEES)*, and all San Bernardino County amendments.

By using these standard plans, the user agrees to release San Bernardino County from any and all claims, liabilities, suits, and demands on account of any injury, damage, or loss to persons or property, including injury or death, or economic losses, arising out of the use of these construction documents. The use of these plans does not eliminate or reduce the user's responsibility to verify any and all information

Consultant
Address
Address
Phone
Fax
e-mail

560 sf ADU

[illegible]



Owner

Roof Framing Plan


Project number	Project Number
Date	Issue Date
Drawn by	Author
Checked by	Checker

S030


Scale	As indicated
-------	--------------

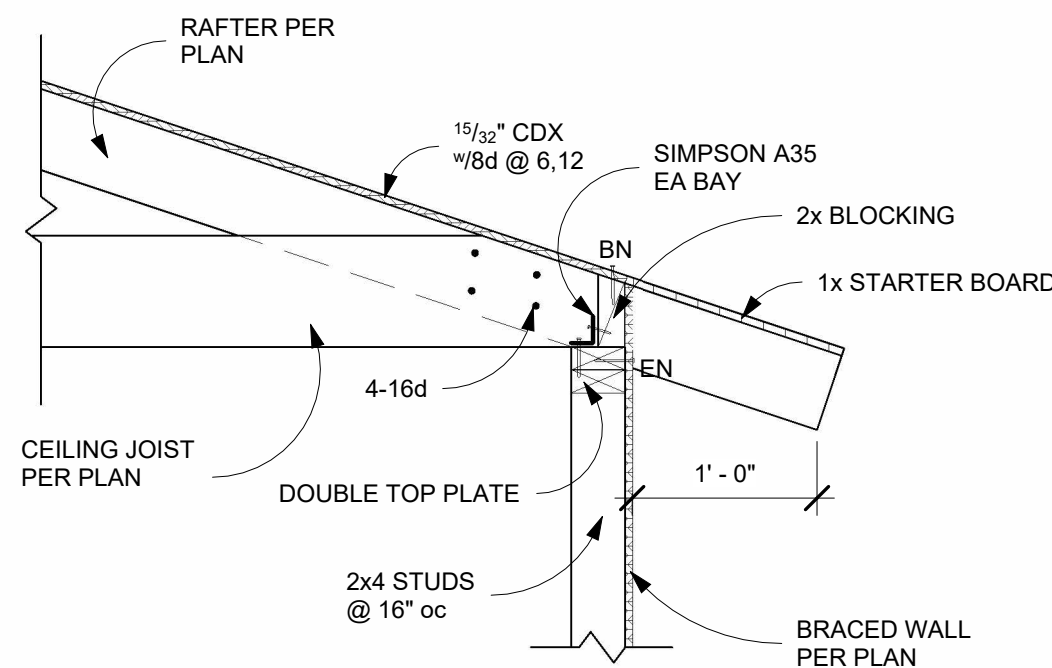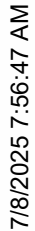

② Exterior- Wall to Roof Diaphragm
1" = 1'-0"

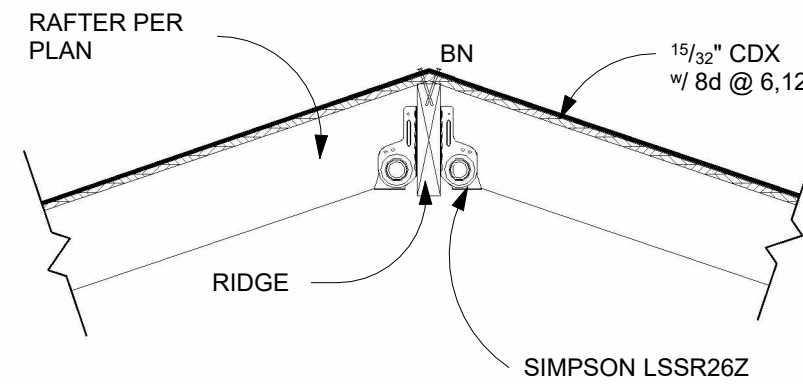

③ Roof-Ridge
1" = 1'-0"

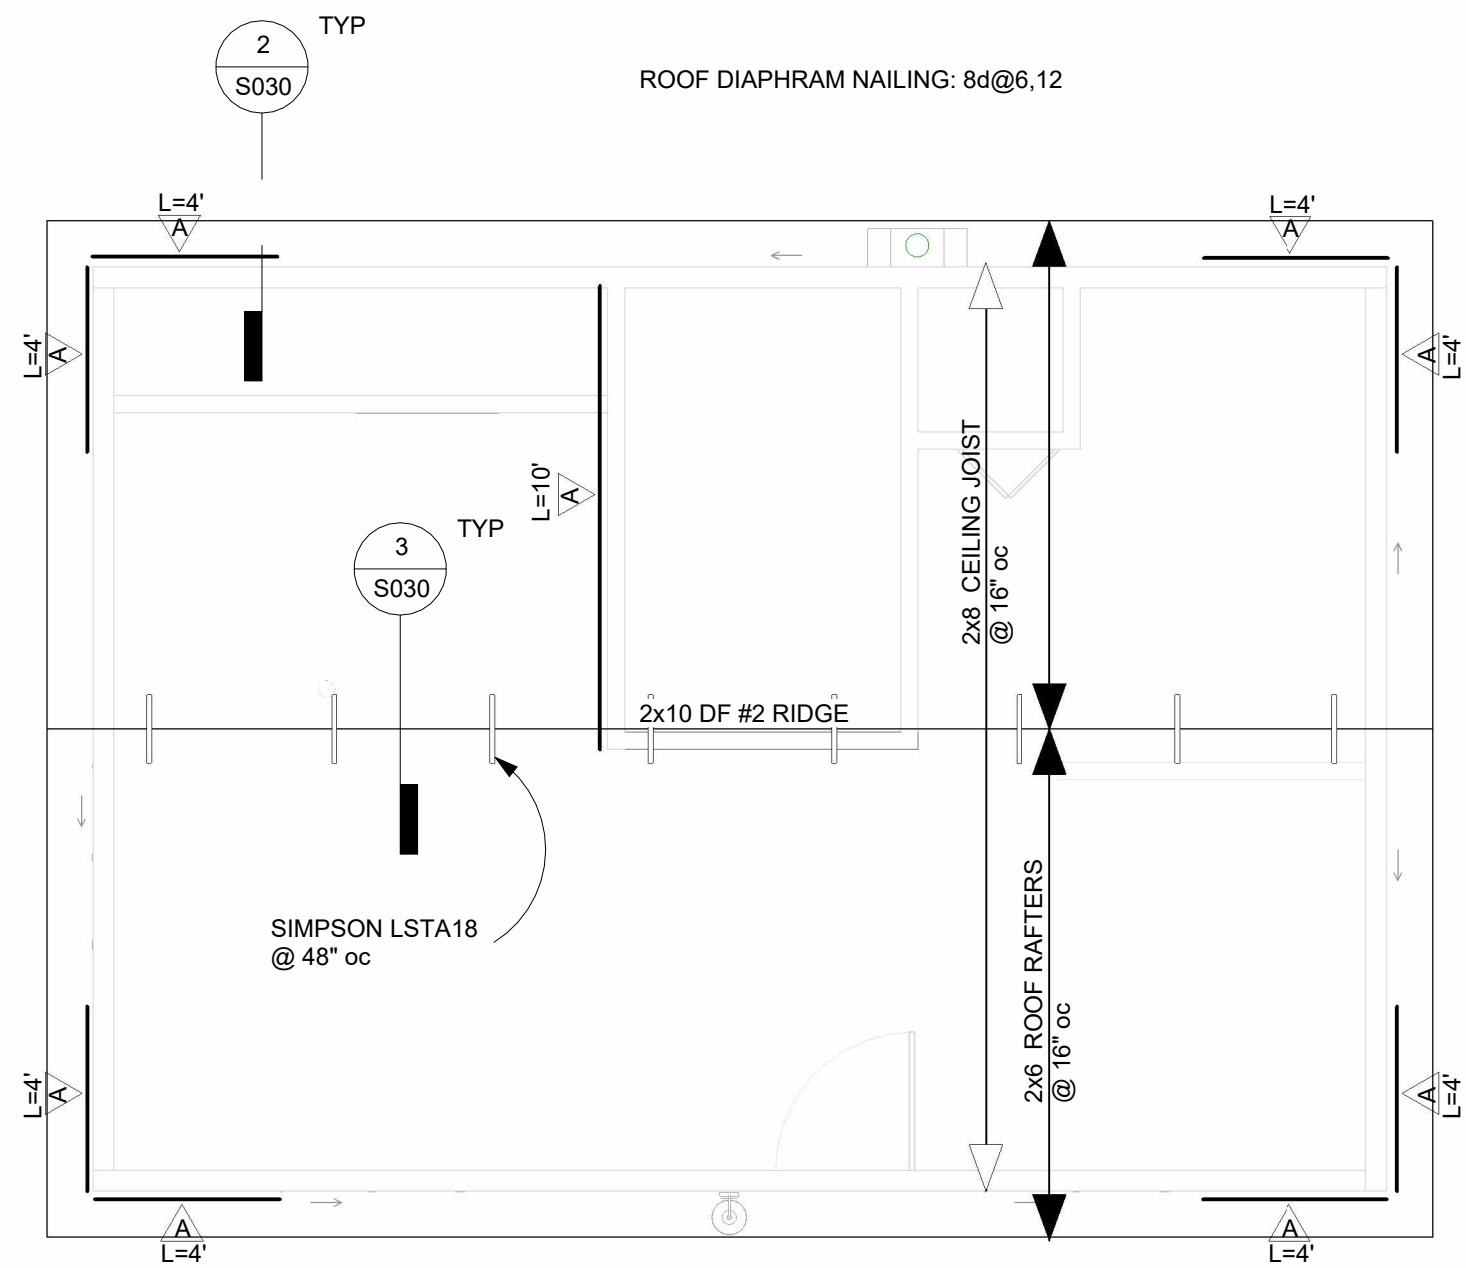

1 Roof
1/4" = 1'-0"