
APPLICABLE CODES: - 2019 CALIFORNIA BUILDING - 2019 CALIFORNIA ELECTRICA				PROPOSING TO HAVE OWNER KIRSCHINER COMPANY LLC TO		SHEET INDEX
- 2019 CALIFORNIA ELECTRICAL CODE - 2019 CALIFORNIA MECHANICAL CODE				OCCUPY THE PROPOSED 4.99 ACRES TO CONSTRUCT A 12,500 SQ. FT. METAL WAREHOUSE BUILDING CONTAINING A 6,000 SQ.		ARCHITECTURAL
 2019 CALIFORNIA PLUMBING 2019 CALIFORNIA ENERGY (2019 CALIFORNIA GREEN BI 	CODE			FT. ADMINISTRATIVE OFFICE WITH 6,500 SQ. FT. OF FREIGHT STORAGE USING 2 LOADING DOCKS. THE SITE PROPOSES 25	T-1	TITLE SHEET
- 2019 CALIFORNIA FIRE COD - CITY OF RIALTO MUNICIPAL	E	AND3 CODE		PASSENGER CAR PARKING & 2 H/C SPACES AND 18 TRUCK AND TRAILER PARKING SPACES AND AN ACRE OF DECOMPOSED	T-2	CONDITIONS OF APPROVAL
ALL WORK SHALL COMPL	Y WITH TH			GRANITE PARKING FOR HEAVY LOW-BOY TRUCKS WITH MOTOR GRADER AND BULLDOZER HEAVY EQUIPMENT THAT WOULD BREAK ASPHALT PARKING. FREIGHT IS RECEIVED VIA TRUCK &	T-3	CONDITIONS OF APPROVAL
AND STATE CODES, (TRAILER AND BROKEN DOWN INTO FREIGHT-FORWARDING CUBES	s	CONDITIONS OF APPROVAL
OCCUPANT LOAD				DESTINATIONS FROM THE WAREHOUSE PORTION. ADMINISTRATIVE OFFICES WITH 10 FULL TIME EMPLOYEES SCHEDULE TRIPS WITH	<u>الم</u>	CIVIL
USE	OCCUPANT LOAD	AREA (SQ. FT.)	NO. OF OCCUPANTS	ASSOCIATED PAPERWORK. WORKING HOURS ARE 24 HOURS A DAY 7 DAYS A WEEK INCLUDING 2 FORKLIFT DRIVERS USING 8	1 OF 2	
WAITING/OFFICE AREA (INCLUDIN ADA RESTROOM & STAIRS)	G 1/150	6,610	44	HOUR SHIFTS.	20F2	PRELIMINARY GRADING PLAN
	1 /500	E 000	10	BRIEF DESCRIPTION OF PROPOSED LOCATION AND SURROUNDING PROPERTIES AS THEY CURRENTLY EXIST:		
STORAGE AREA	1/500	5,890	12	THE PROPERTY IS VACANT AND ALWAYS HAS BEEN VACANT	A-1	
			56	LOCATED ON LIME AVENUE AN UN-FINISHED 2 LANE STREET WHICH OWNER PROPOSES TO DEVELOP 1/2 WIDTH TO	A-1.1 A-1.2	GREEN BUILDING NOTES GREEN BUILDING NOTES
REQUIRED NUMBER OF EXITS FO			IS = 1	COMPLETE. TO THE NORTH IS A VACATED RAIL WAY RIGHT OF WAY, TO THE EAST IS VACANT FIELDS, TO THE SOUTH IS AN	A-1.2	GREEN BUILDING NOTES
	C TABLE 1006. H OF EGRESS			OPERATING MANUFACTURING COMPANY, AND TO THE WEST ACROSS LIME AVENUE IS A PROPANE DISTRIBUTION FACILITY.	A-1.4	SITE DETAILS
B, S OCCUPANCIES WITHOUT			VEL MAX.	LOGISTICS: THERE ARE PRESENTLY 18 TRUCK & TRAILERS WITH MOST	A-1.5	LIGHT SPECS
	PRINKLERS 100			TRACTORS BEING OWNED AND OPERATED BY CONTRACTED DRIVERS AS WELL AS COMPANY OWNED WHO PROPOSE 9	A-1.6	TRASH ENCLOSURE SHEET
2019 SPACES WITH ONE	CBC TABLE 10 FXIT OR FXIT		ORWAY	TRUCK TRIPS OUT AND 9 TRUCK TRIPS IN-BOUND 7 DAYS A WEEK. HEAVY EQUIPMENT TRUCK TRIPS AVERAGE 2 OUTBOUND	A-2	PROPOSED FLOOR PLAN
OCCUPANCY B MAX OCCUPANT	LOAD 49 / F	PROPOSED 4		AND 2 IN-BOUND EVERY 5 DAYS AND ARE DELIVERED TO JOB SITES AS A SERVICE TO GRADING CONTRACTORS. BUSINESS		REFLECTED CEILING PLAN/EGRESS PLAN
OCCUPANCY S MAX OCCUPANT EXITS REQUIRED FOR B OCCUP				HOUSE ARE 7 DAYS A WEEK USING 10 OFFICE PERSONNEL AND 2 FORK LIFT DRIVERS AND AN AVERAGE OF 5 TRUCK	A-2.2 A-2.3	LIGHTING SPECS LIGHTING SPECS CONT.
EXITS REQUIRED FOR S OCCUP		3		DRIVERS TEMPORARILY ON SITE TO BEGIN THE SHIFT OR END THE SHIFT.		T-BAR CEILING NOTES AND DETAILS
TOTAL EXITS PROVIDED		6				ACCESSIBILITY NOTES AND DETAILS
2019 CPC /	NALYSIS TABL	E 422.1			A-2.6	ENLARGED RESTROOM PLANS AND ELEVATION
MINIMUM F OCCUPANCY LOAD B: 44 (50%	PLUMBING FAC				A-2.7	OFFICE AND KITCHEN LAYOUTS & ELEVATIONS
OCCUPANCY LOAD S: 12 (50%	PER GENDER =	: 6/6)			A-2.8	KITCHEN ELEVATIONS & SECTIONS/DETAILS
1:1-50 PERSONS FOR F OCCUP WATER CLOSETS/PERSON		MENTS FEMALE: 2				EXTERIOR ELEVATIONS
URINALS/PERSON	1					SECTIONS
LAVATORIES/PERSON BATHTUBS/SHOWERS/PERSON	MALE: 1 (NO FX)	FEMALE: 1 CESSIVE HEA	Г.		A-3.2 A-4	SIGHT-LINE ROOF PLAN
CONTAMINANTS, OR INFECTIOUS,						ELECTRICAL
METAL FABRICATION) DRINKING FOUNTAINS/FACILITIES	1				E-0	SINGLE LINE & DETAIL
OTHER		CE SINK			E-0.1	SITE PLAN
S OCCUPANCY REQUIREMENTS					E-1	DETAIL
1:1–100 WATER CLOSETS 1:1–200 LAVATORIES					E-2	DETAIL
WATER CLOSETS/PERSON		FEMALE: 1			E-3.1	OUTDOOR PHOTOMETRIC PLAN
URINALS/PERSON LAVATORIES/PERSION	N/A MALE: 1	FEMALE: 1			E-3.2	
BATHTUBS/SHOWERS/PERSON	N/A				E-3.3 E-4	OUTDOOR PHOTOMETRIC PLAN TITLE 24
DRINKING FOUNTAINS/FACILITIES OTHER		CE SINK			E-4 E-5	POWER PLAN
(3) UNISEX RESTROOMS PROV	DFD FOR FNT	IRF RUIII DINC	. 5		E-6	CEILING PLAN
OCCUPANCY IS ACCESSORY TO			. .		E-7	INDOOR LIGHTING TITLE 24
2019 CBC ALLOWABLE	AREA ANALYSI	s per chap	TER 5			MECHANICAL
504.3 ALLOWABLE BUILDING HEIGHT	IN FEET ABOVE G	RADE PLANE			M-1	MECHANICAL DETAIL
FOR OCCUPANCIES B, F, M, S, U TYPE II-B CONSTRUCTION: 7	5'				M-2	ROOF PLAN & A/C DUCT PLAN
504.4 ALLOWABLE NUMBER OF STOR					M-3	MECHANICAL TITLE 24
TYPE II-B CONSTRUCTION:	B OCCUPANCY S OCCUPANC	• • • • •	(S)		M-4	MECHANICAL TITLE 24
						PLUMBING
506.2.4 MIXED-OCCUPANCY, MULTIS MIXED-OCCUPANCY BUILDING WITH M	ORE THAN ONE S	STORY ABOVE	GRADE PLANE		P-0	SITE PLAN
SHALL INDIVIDUALLY COMPLY WITH T 508.1.	he applicable f	(EQUIREMENTS	UF SECTION		P-1	PLUMBING PLAN
EQUATION 5-1					P-2	WASTE PLAN
$A_{\alpha} = A_{t} + (NS \times I_{f})$ where:						
A_{\circ} = Allowable Area (Square Fe At = TABULAR Allowable Area Fa		R SI3R VALUE	AS		GN S1	GENERAL NOTES
APPLICABLE) IN ACCORDANCE WITH NS = TABULAR ALLOWABLE AREA F	TABLE 506.2.				S1 SD1	FOUNDATION PLAN CONSTRUCTION DETAILS
NONSPRINKLERED BUILDING (REGARD						EMPIRE STEEL (IIXI7 SHEET
SPRINKLERED). It = AREA FACTOR INCREASE DUE T	D FRONTAGE (PEF	RCENT) AS CAL	CULATED IN		4.04	
ACCORDANCE WITH SECTION 506.3.	·				1-34 1-5	PERMIT PLANS (DETAILS) PLANS
$A_{\sigma} = A_t + (NS \times I_f) = 27,000 + (23)$ $A_{\sigma} = 92,000 + (0)$,000 × 0)				1-0	
$A_{a} = 92,000 + (0)$ $A_{a} = 92,000 \text{ SQ. FT. FOR B}$ $A_{a} = A_{t} + (NS \times I_{f}) = 70,000 + (17)$	500 ~ 0					LANDSCAPE PLANS
$A_a = 70,000 + (0)$,					CONCEPT PLANTING & SCHEDULE NOTES CONCEPT PLANTING PLAN
$A_{e} = 70,000 \text{ SQ}, \text{ FT. FOR S-1}$	00 000 00 -					
TOTAL ALLOWABLE BUILDING AREA =	= 70,000 SQ. FT.	FOR S-1 OCC	JPANCY			
TOTAL PROPOSED BUILDING AREA -	<u>HOUSE)</u>					
TOTAL PROPOSED BUILDING AREA = (FOOTPRINT (FOR S-1 OCCU	PANCY			
508.1 GENERAL. EACH PORTION OF	•	l be individua	LLY CLASSIFIED			
IN ACCORDANCE WITH SECTION 302. ONE OCCUPANCY GROUP, THE BUILD	1. WHERE A BUILI					
OR PORTION THEREOF SHALL COMPL SECTION 508.2, 508.3 OR 508.4, OF	Y WITH THE APPI					
508.3 NONSEPARATED OCCUPANCIES						
COMPLY WITH THE PROVISIONS OF T NONSEPARATED OCCUPANCIES.						
508.3.1 OCCUPANCY CLASSIFICATION						
INDIVIDUALLY CLASSIFIED IN ACCORE	ANCE WITH SECTI	ON 302.1. THE	REQUIREMENTS			
OF THIS CODE SHALL APPLY TO EA OCCUPANCY CLASSIFICATION OF TH/	T SPACE. IN ADD	DITION, THE MOS	ST RESTRICTIVE			
PROVISIONS OF CHAPTER 9 WHICH A SHALL APPLY TO THE TOTAL NONSE	PARATED OCCUP	ANCY AREA.				
508.3.1.1 WHERE NONSEPARATED THE MOST RESTRICTIVE REQUIREM	ENTS OF SECTION	403 WHICH AF	PLY TO THE			
NONSEPARATED OCCUPANCIES SHA BUILDING.						
508.3.2 ALLOWABLE BUILDING AREA						
AND HEIGHT OF THE BUILDING OR F MOST RESTRICTIVE ALLOWANCES FOR	ORTION THEREOF	SHALL BE BAS	ED ON THE			
		THE BUILDING		I	1	

ROJECT INFORMATION: KIRSCHNER COMPANY, LLC 14029 Springwater Ln Eastvale CA 92880 Phone: 951-750-2736	OF	ficial Use Only
0232-061-22-0000 NEYARD TRACT ALL THAT PTN LOTS 133 A WLY OF SWLY LI PE RR R/W 4.987 AC ONE: REGIONAL INDUSTRIAL (I-R) D) SERVICE COMMERCIAL (CS)	M/L San Bernardino (Azhar Khan 11.9	County Planning Review .2021 Sixth Review
6,610 SQ. FT. EIGHT AREA: 5,890 SQ. FT	а. гт.	0
GE: 184,350 SQ. FT. = 83.5 2 & PAVEMENT CALCULATION:		
1220000 = 220,668 SQ. FT. ~ 5.06 AC	2.	
APE REQUIRED <u>220,668 SQ. FT. = 33,100 SQ. FT.</u> ED = 36,318 SQ. FT. = 1 F PROPOSED LANDSCAPE TO BE DECORAT D COVERING.		
* 0.30 = 10,895 sq. ft. TIVE GROUND COVER TO BE AT REAR MO NS OF SITE; REAR YARD, REAR PORTIONS ARDS. FRONT YARD LANDSCAPE TO BE TION/LIVE LANDSCAPE	OF	
PAVED AREA = 171,850 SQ. FT. = 77.8% PVIOUS AREA = 138,838 SQ. FT. = 8 OUS AREA = 33,012 SQ. FT. (DG)	30.8%	
INFORMAITON		
ON TYPE: II-B D: YES 1		
DOTPRINT: 12,500 SQ. FT. A: 6,610 SQ. FT. LDING) REIGHT AREA: 5,890 SQ. FT.		
URVEYORS		
NTANA WATER COMPANY 5970, EL MONTE, CA 91734 –2201		
SOUTHER CALIFORNIA EDISON COMP OTHILL BLVD., UPLAND, CA 92501 5861	PANY	
I GAS COMPANY AGONIA AVE., REDLANDS, CA 92373 —2686	5	
RIZON FIOS NGE ST., RIVERSIDE, CA 92501 —9900		
PARKING ANALYSISPER TABLE 83-15 COUNTY OF SANBERNARDINO MUNICIPAL CODE/250 SQ. FT.)6,610STORAGE (1/1,000 SQ. FT.)5,890ZONE5,890	27 6	
FT.) 200 REQ. = 2 G SPACES REQ. = 34	1 34	
G SPACES PROVIDED = 34 RKING SPACES PROVIDED = 2 (VAN ACCESS O OFF-STREET PARKING AND LOADING AREAS WITH A MINIMUM OF TWO INCH (MIN.) ASPH /ING.	ARE TO	
OXES WILL BE INSTALLED AT ALL PROP EXTERIOR LIGHTING TO MEET THE FOLI PASSENGER VEHICLE PARKING AREA SH LLUMINATED AT A MINIMUM OF 1.5 FOC DLES.	LOWING: HALL	
TRUCK YARD AREAS SHALL BE ILLUMIN A MINIMUM OF 1.0 FOOT CANDLES. ACT FEES WILL BE PAID IN FULL PRIOF G PERMIT ISSUANCE		
PERMIT APPLICATIONS ARE REQUIRE UBLIC WORKS, FIRE SPRINKLER, PTIC SYSTEMS, AND/OR EXTERIOR SIGNAGE.	D FOR	
		16689 E Foothill Blyd, #205
VICINITY MAP N.T.S.	LANDIN & ASSOCIATES DESIGN CONSULTANTS	16689 E Foothill Blvd. #205 Fontana, Ca. 92335 Iandin.associates@gmail.com
	NO DATE BY REMARKS	REVISIONS
	DRAWING TITLE	DRAWN BY: J.S. CHECKED: A.L.
PROJECT STE	TITLE SHEET	DATE: T-1 SCALE: AS NOTED
	- The	JOB NO.

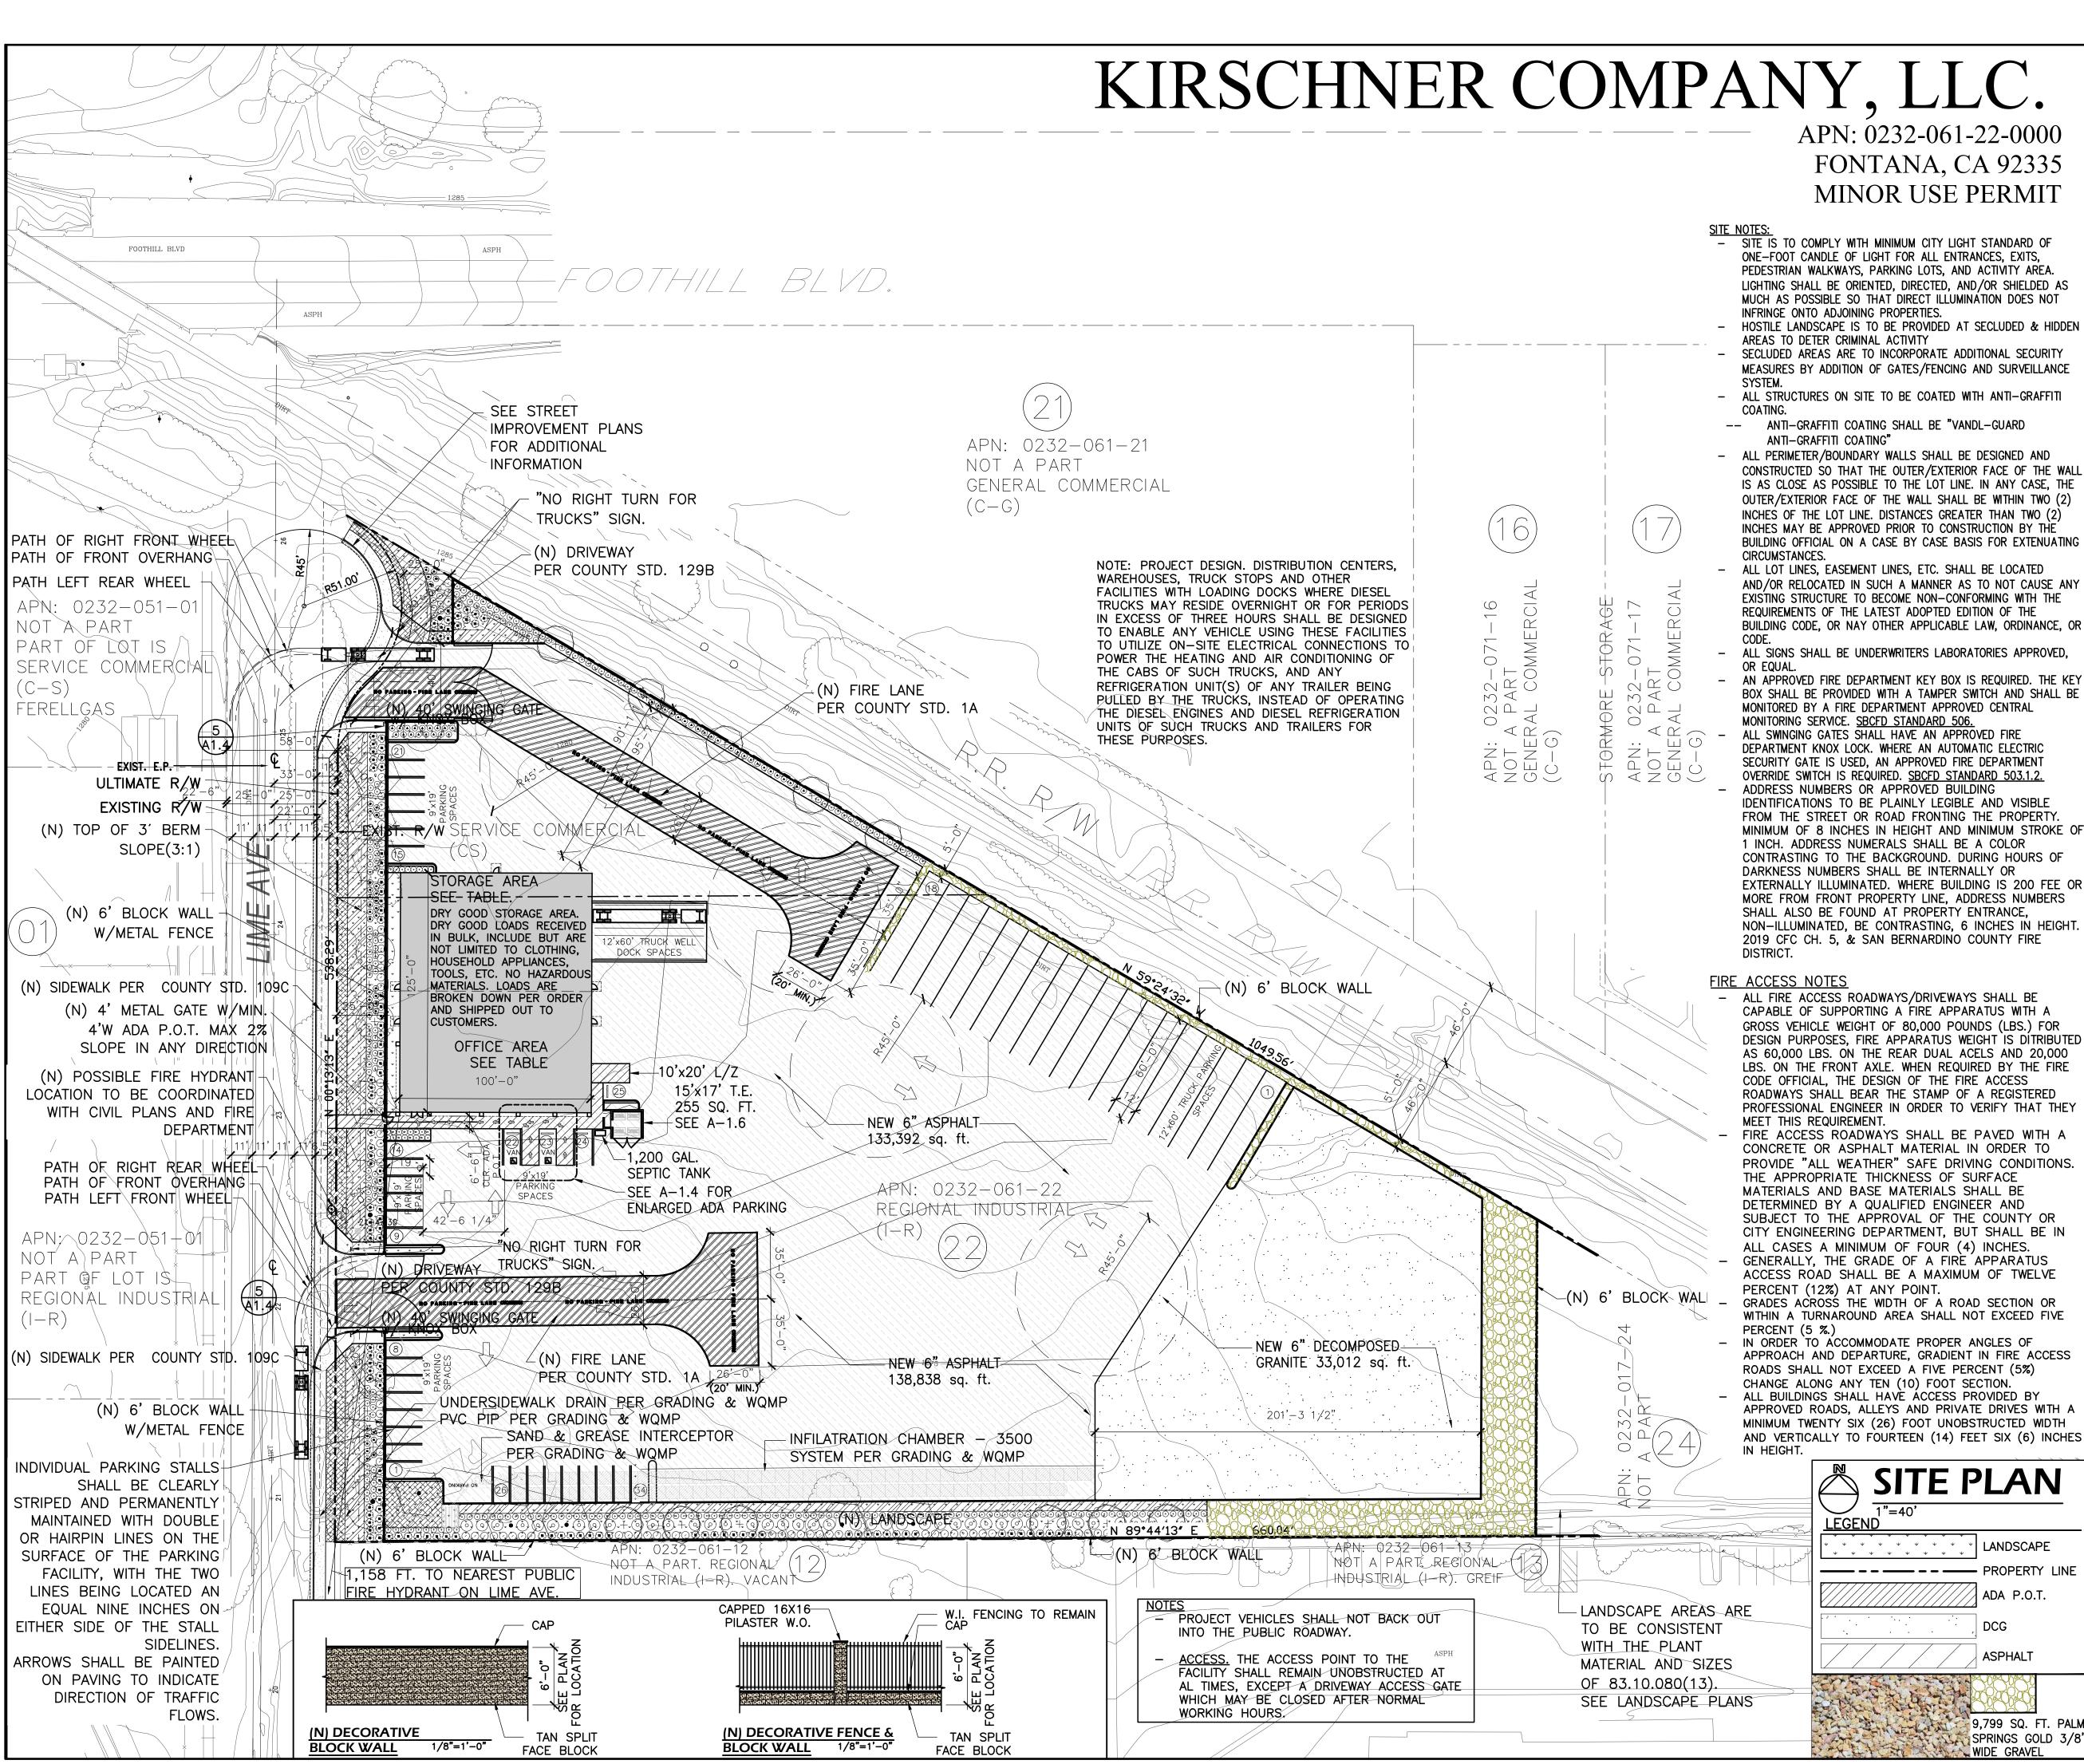

Y, LLC.	OFFICIAL USE ONLY
PN: 0232-061-22-0000	
FONTANA, CA 92335	
MINOR USE PERMIT	
OMPLY WITH MINIMUM CITY LIGHT STANDARD OF ANDLE OF LIGHT FOR ALL ENTRANCES, EXITS, WALKWAYS, PARKING LOTS, AND ACTIVITY AREA. LL BE ORIENTED, DIRECTED, AND/OR SHIELDED AS SSIBLE SO THAT DIRECT ILLUMINATION DOES NOT O ADJOINING PROPERTIES. PSCAPE IS TO BE PROVIDED AT SECLUDED & HIDDEN TER CRIMINAL ACTIVITY EAS ARE TO INCORPORATE ADDITIONAL SECURITY ADDITION OF GATES/FENCING AND SURVEILLANCE	
RES ON SITE TO BE COATED WITH ANTI-GRAFFITI	
AFFITI COATING SHALL BE "VANDL-GUARD AFFITI COATING" R/BOUNDARY WALLS SHALL BE DESIGNED AND SO THAT THE OUTER/EXTERIOR FACE OF THE WALL AS POSSIBLE TO THE LOT LINE. IN ANY CASE, THE IOR FACE OF THE WALL SHALL BE WITHIN TWO (2) HE LOT LINE. DISTANCES GREATER THAN TWO (2) BE APPROVED PRIOR TO CONSTRUCTION BY THE ICIAL ON A CASE BY CASE BASIS FOR EXTENUATING ES. S, EASEMENT LINES, ETC. SHALL BE LOCATED	
DCATED IN SUCH A MANNER AS TO NOT CAUSE ANY JCTURE TO BECOME NON-CONFORMING WITH THE S OF THE LATEST ADOPTED EDITION OF THE	

- ALL SIGNS SHALL BE UNDERWRITERS LABORATORIES APPROVED,

L DEI ANTIMENT NET DOX 15 NEQUINED: THE NET
ROVIDED WITH A TAMPER SWITCH AND SHALL BE
FIRE DEPARTMENT APPROVED CENTRAL
/ICE. <u>SBCFD_STANDARD_506.</u>
TES SHALL HAVE AN APPROVED FIRE
DX LOCK. WHERE AN AUTOMATIC ELECTRIC
S USED, AN APPROVED FIRE DEPARTMENT
IS REQUIRED. <u>SBCFD STANDARD 503.1.2.</u>
ERS OR APPROVED BUILDING
TO BE PLAINLY LEGIBLE AND VISIBLE
EET OR ROAD FRONTING THE PROPERTY.
INCHES IN HEIGHT AND MINIMUM STROKE OF
SS NUMERALS SHALL BE A COLOR
O THE BACKGROUND. DURING HOURS OF
BERS SHALL BE INTERNALLY OR
UMINATED. WHERE BUILDING IS 200 FEE OR
ONT PROPERTY LINE, ADDRESS NUMBERS
FOUND AT PROPERTY ENTRANCE,
ED, BE CONTRASTING, 6 INCHES IN HEIGHT.
5, & SAN BERNARDINO COUNTY FIRE

<u>IES</u>
ESS ROADWAYS/DRIVEWAYS SHALL BE
SUPPORTING A FIRE APPARATUS WITH A
E WEIGHT OF 80,000 POUNDS (LBS.) FOR
SES, FIRE APPARATUS WEIGHT IS DITRIBUTED
S. ON THE REAR DUAL ACELS AND 20,000
FRONT AXLE. WHEN REQUIRED BY THE FIRE
, THE DESIGN OF THE FIRE ACCESS
ALL BEAR THE STAMP OF A REGISTERED
ENGINEER IN ORDER TO VERIFY THAT THEY

ROADWAYS SHALL BE PAVED WITH A
ASPHALT MATERIAL IN ORDER TO
WEATHER" SAFE DRIVING CONDITIONS.
ATE THICKNESS OF SURFACE
ND BASE MATERIALS SHALL BE


BY A QUALIFIED ENGINEER AND
THE APPROVAL OF THE COUNTY OR
RING DEPARTMENT, BUT SHALL BE IN
MINIMUM OF FOUR (4) INCHES.
HE GRADE OF A FIRE APPARATUS
SHALL BE A MAXIMUM OF TWELVE
() AT ANY POINT.

GRADES ACROSS THE WIDTH OF A ROAD SECTION OR WITHIN A TURNAROUND AREA SHALL NOT EXCEED FIVE

- IN ORDER TO ACCOMMODATE PROPER ANGLES OF APPROACH AND DEPARTURE, GRADIENT IN FIRE ACCESS ROADS SHALL NOT EXCEED A FIVE PERCENT (5%) CHANGE ALONG ANY TEN (10) FOOT SECTION. - ALL BUILDINGS SHALL HAVE ÁCCESS PROVIDED BY APPROVED ROADS, ALLEYS AND PRIVATE DRIVES WITH A MINIMUM TWENTY SIX (26) FOOT UNOBSTRUCTED WIDTH AND VERTICALLY TO FOURTEEN (14) FEET SIX (6) INCHES


SITE PLAN 1"=40' EGEND LANDSCAPE	& ASS	6 🗆 0	DIN CIATES SULTANTS	16689 E Foothill Bly Fontana, Ca. 92 Iandin.associates@gr	vd. #205 2335 mail.com
				REVISIONS	
ADA P.O.T.	NO DATE	BY -	REMARKS		
DCG					
ASPHALT	DRAWING TITLE	<u> </u>		DRAWN BY: J.S.	
	SITE PL	AN		CHECKED: A.L. DATE:	A-1
9,799 SQ. FT. PALM SPRINGS GOLD 3/8" WIDE GRAVEL				SCALE: AS NOTED JOB NO.	


Ph

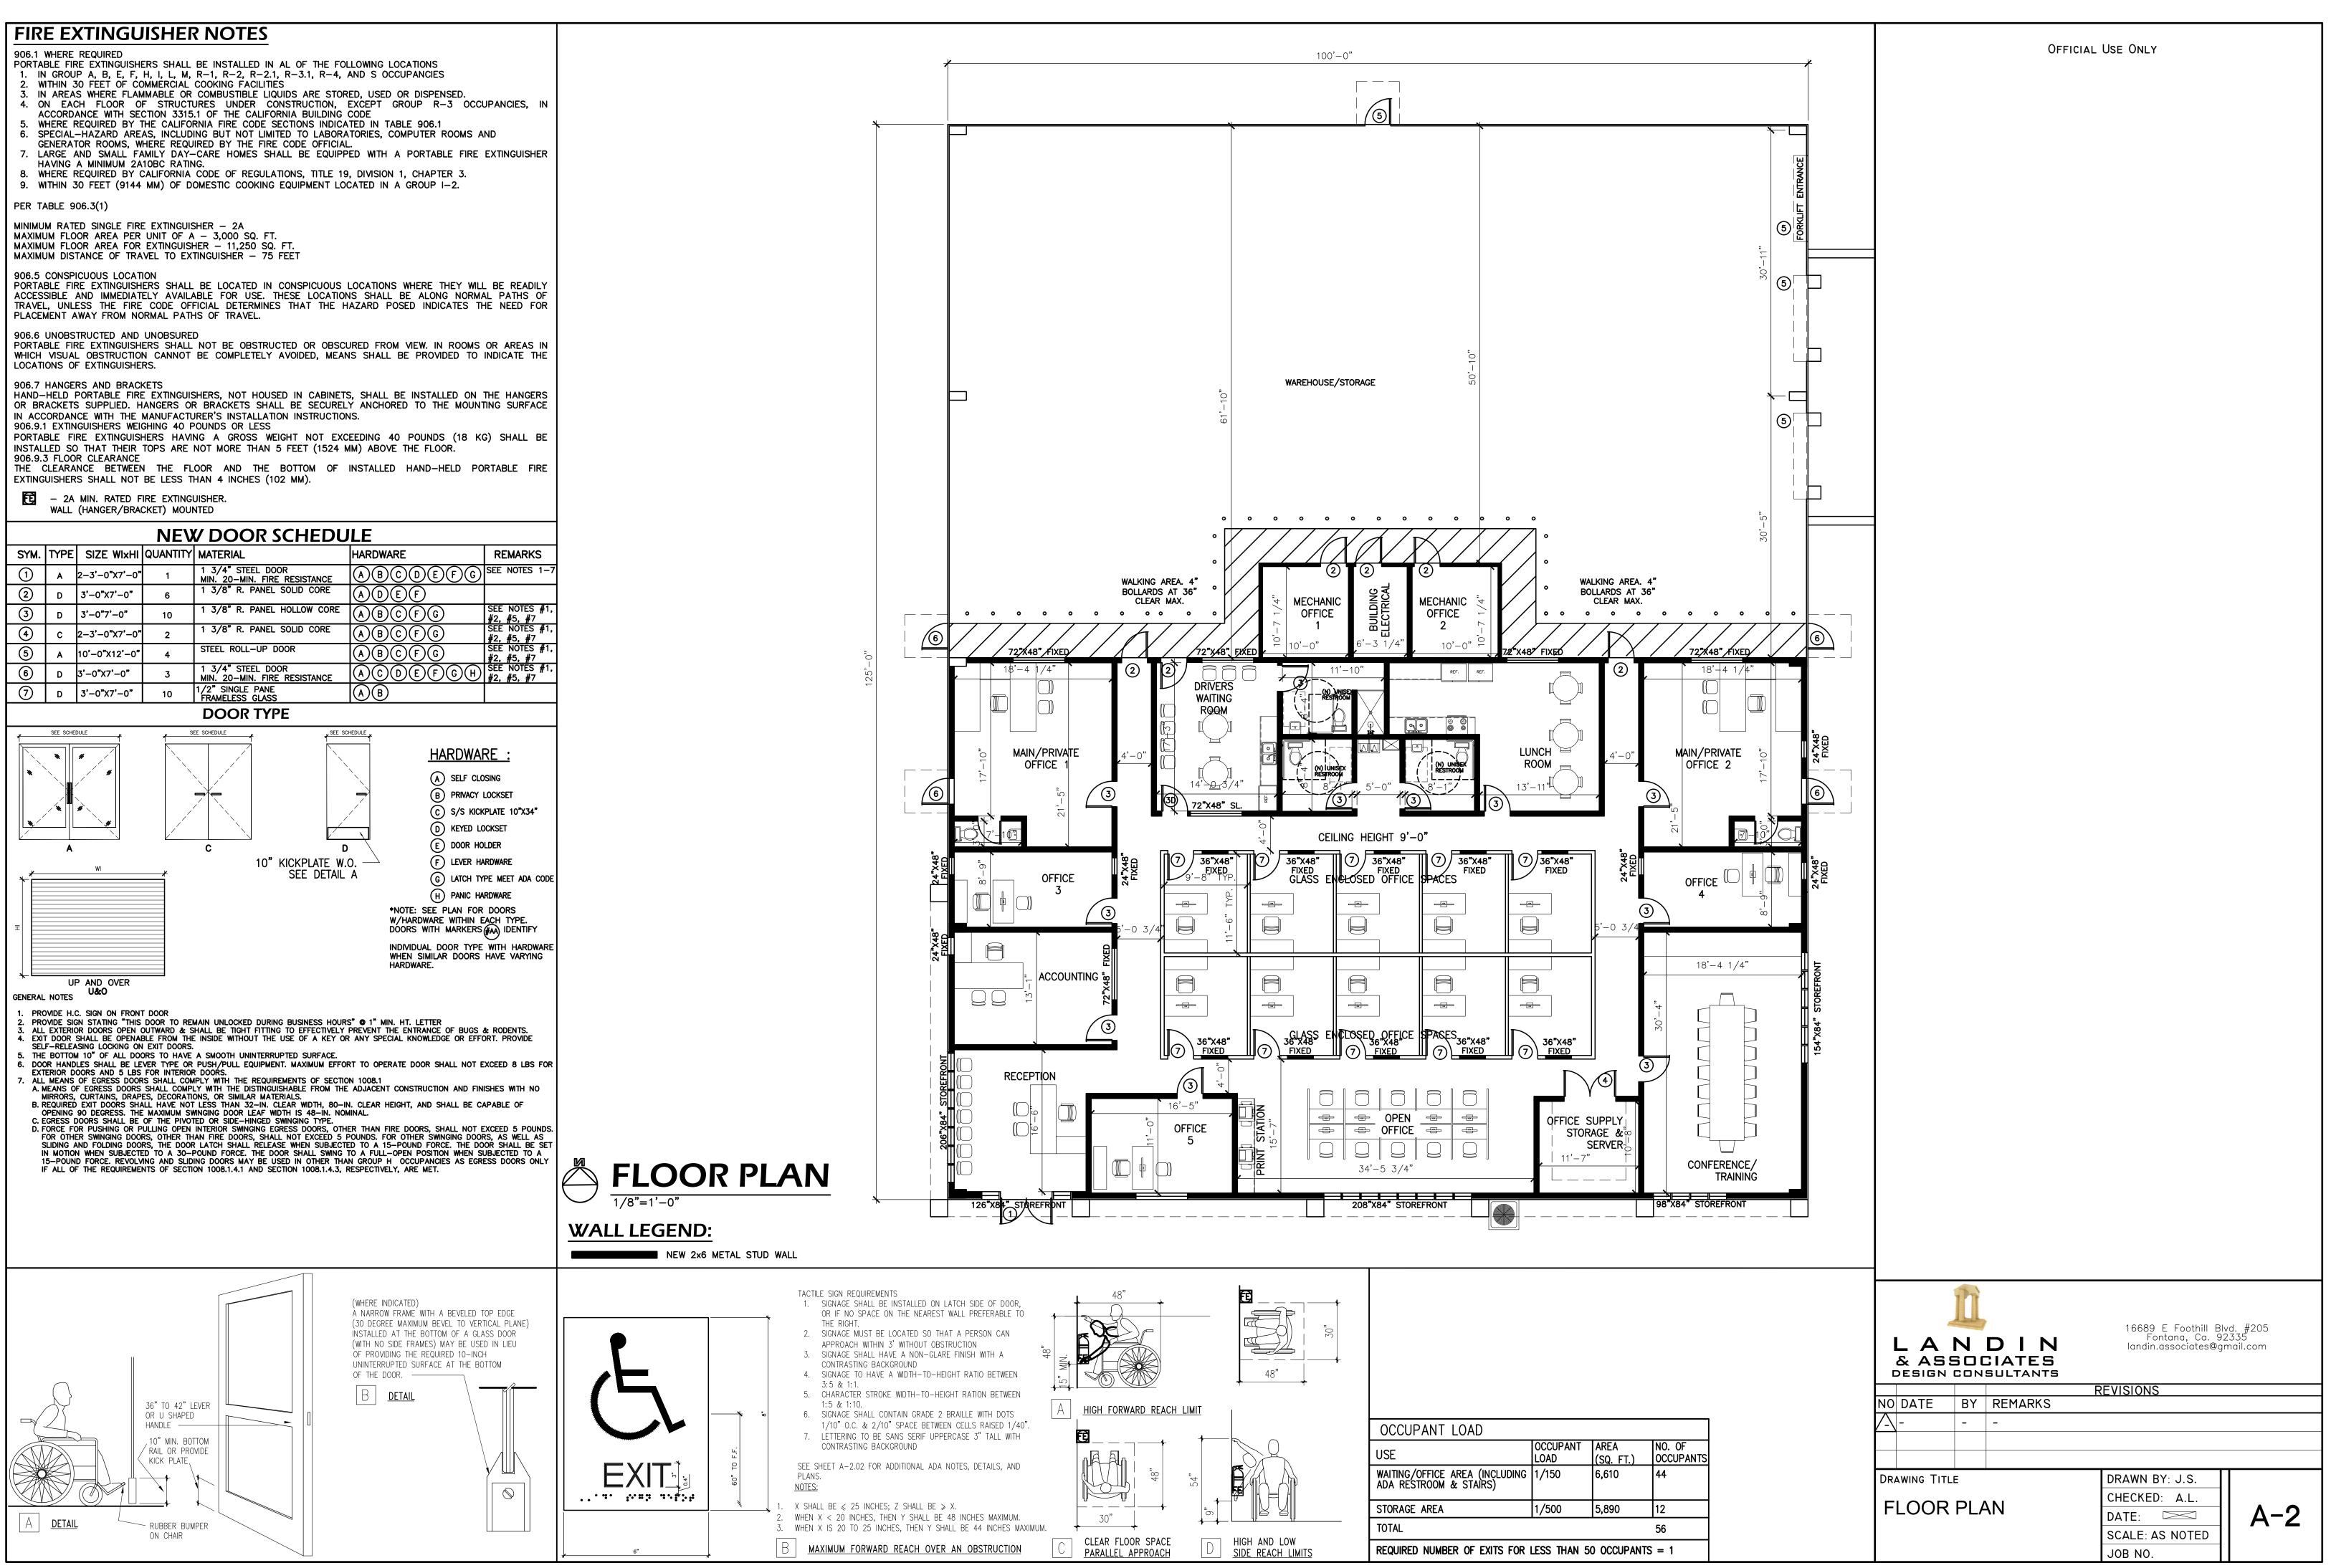






1	7/8" STANDARD FINISH CONC. STUCCO. 3 COAT APPLICATION. PAINTED SHERWIN-WILLIAMS "GOASSAMER VEIL" SW9165 238-C1
2	HARRISTONE HAVANNAH MASON'S CHOICE VENEER PER ICC—ESR 1593. OVER 2 LAYERS OF GRADE "D" PAPER.
3	STEEL SIDING PER MANUFACTURER. COLOR PER MANUFACTURER. COLOR AND MANUFACTURER SHOWN ARE: ASH GRAY BY EMPIRE STEEL
	SHEET METAL DECORATIVE TRIM & CANOPY (SOLID ROOF SHADE STRUCTURE PER CALGREEN 5.407.2.2.1) PAINTED SHERWIN-WILLIAMS "FIREWEED" SW 6328
	METAL ROLL UP DOOR PER PLANS PAINTED SHERWIN-WILLIAMS "PEPPERCORN" SW 7674 SHIELDED EXTERIOR LIGHT WITH PHOTO AND MOTION SENSOR. SEE ELECTRICAL PLANS FOR
7	Ø4" GALV. STL. DOWNSPOUT FROM ROOF DRAIN
	EDGE OF DOCK LEVELER (DLM EOD 3011 W/B72 NEVER LIFT-NL7220 15" LIP. TYP.)
9	OR APPROVED EQUAL STOREFRONT GLAZING
10	EGRESS DOOR
11	HVAC EQUIPMENT
13	ADDRESS NUMBERS OR APPROVED BUILDING IDENTIFICATIONS TO BE PLAINLY LEGIBLE AND VISIBLE FROM THE STREET OR ROAD FRONTING THE PROPERTY. MINIMUM OF 12 INCHES IN HEIGHT AND MINIMUM STROKE OF 1 INCH. ADDRESS NUMERALS SHALL BE A COLOR CONTRASTING TO THE BACKGROUND 2016 CFC CH. 5, & SAN BERNARDINO COUNTY FIRE DISTRICT

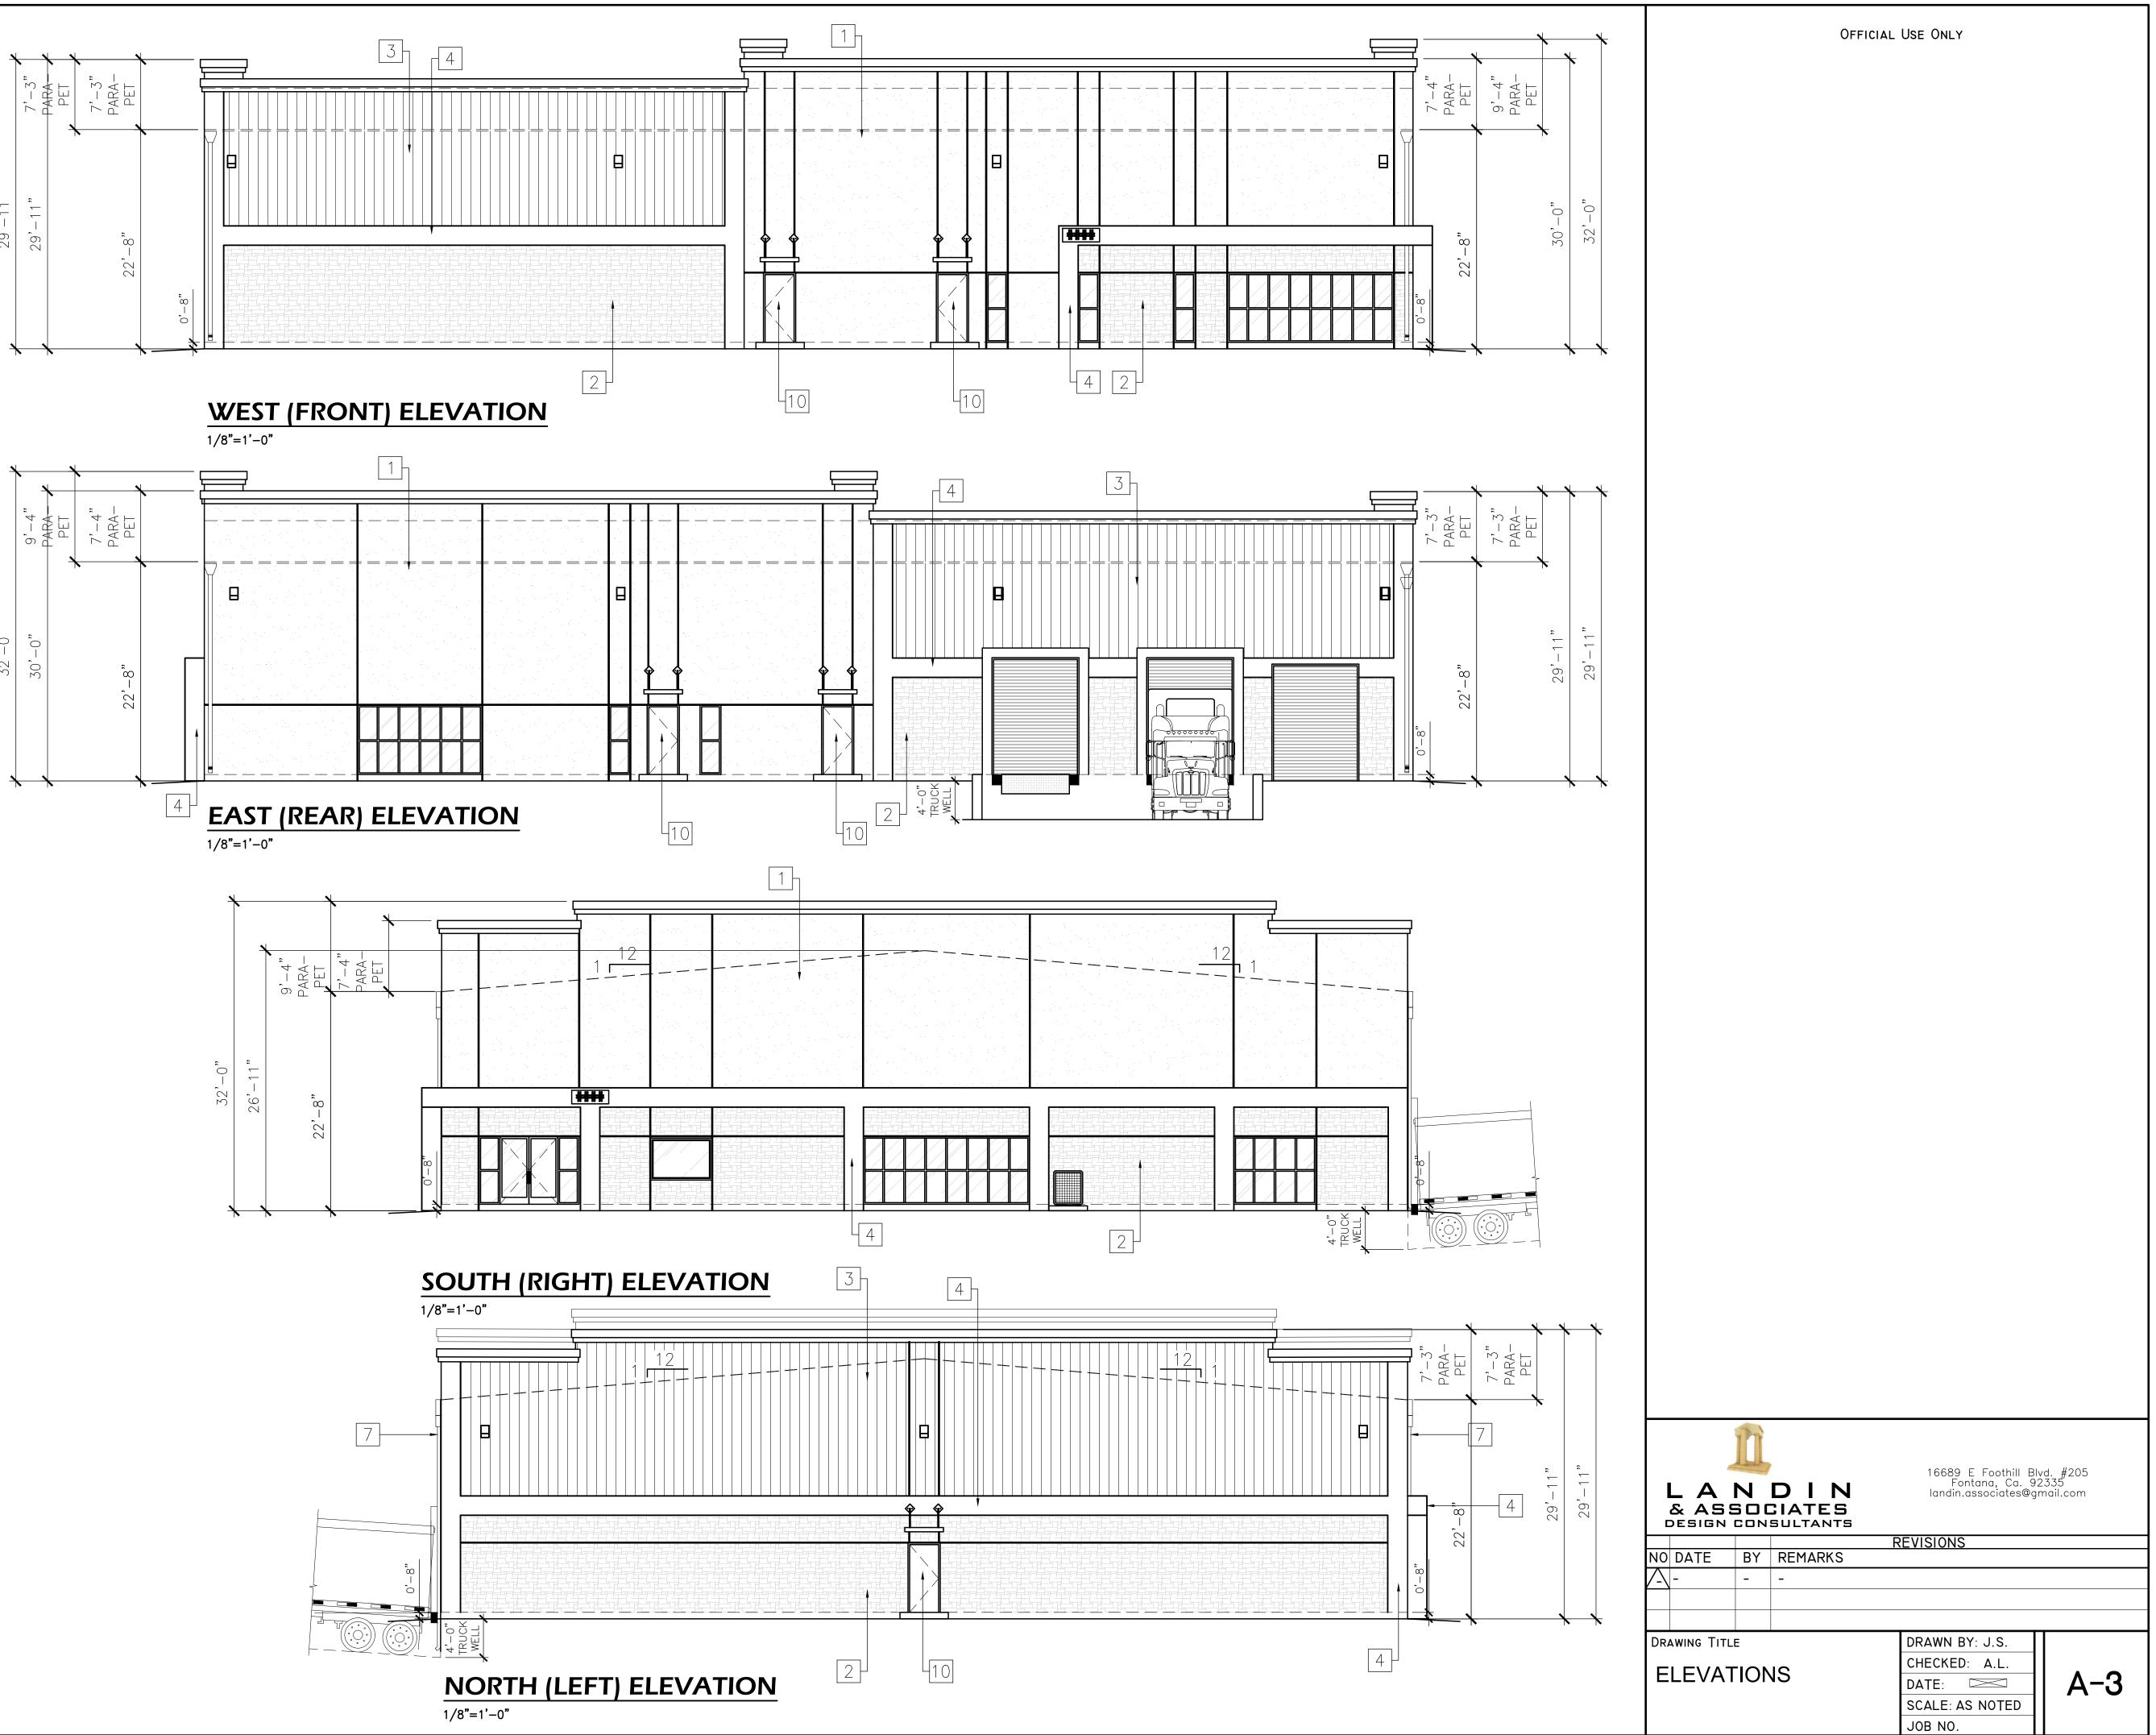

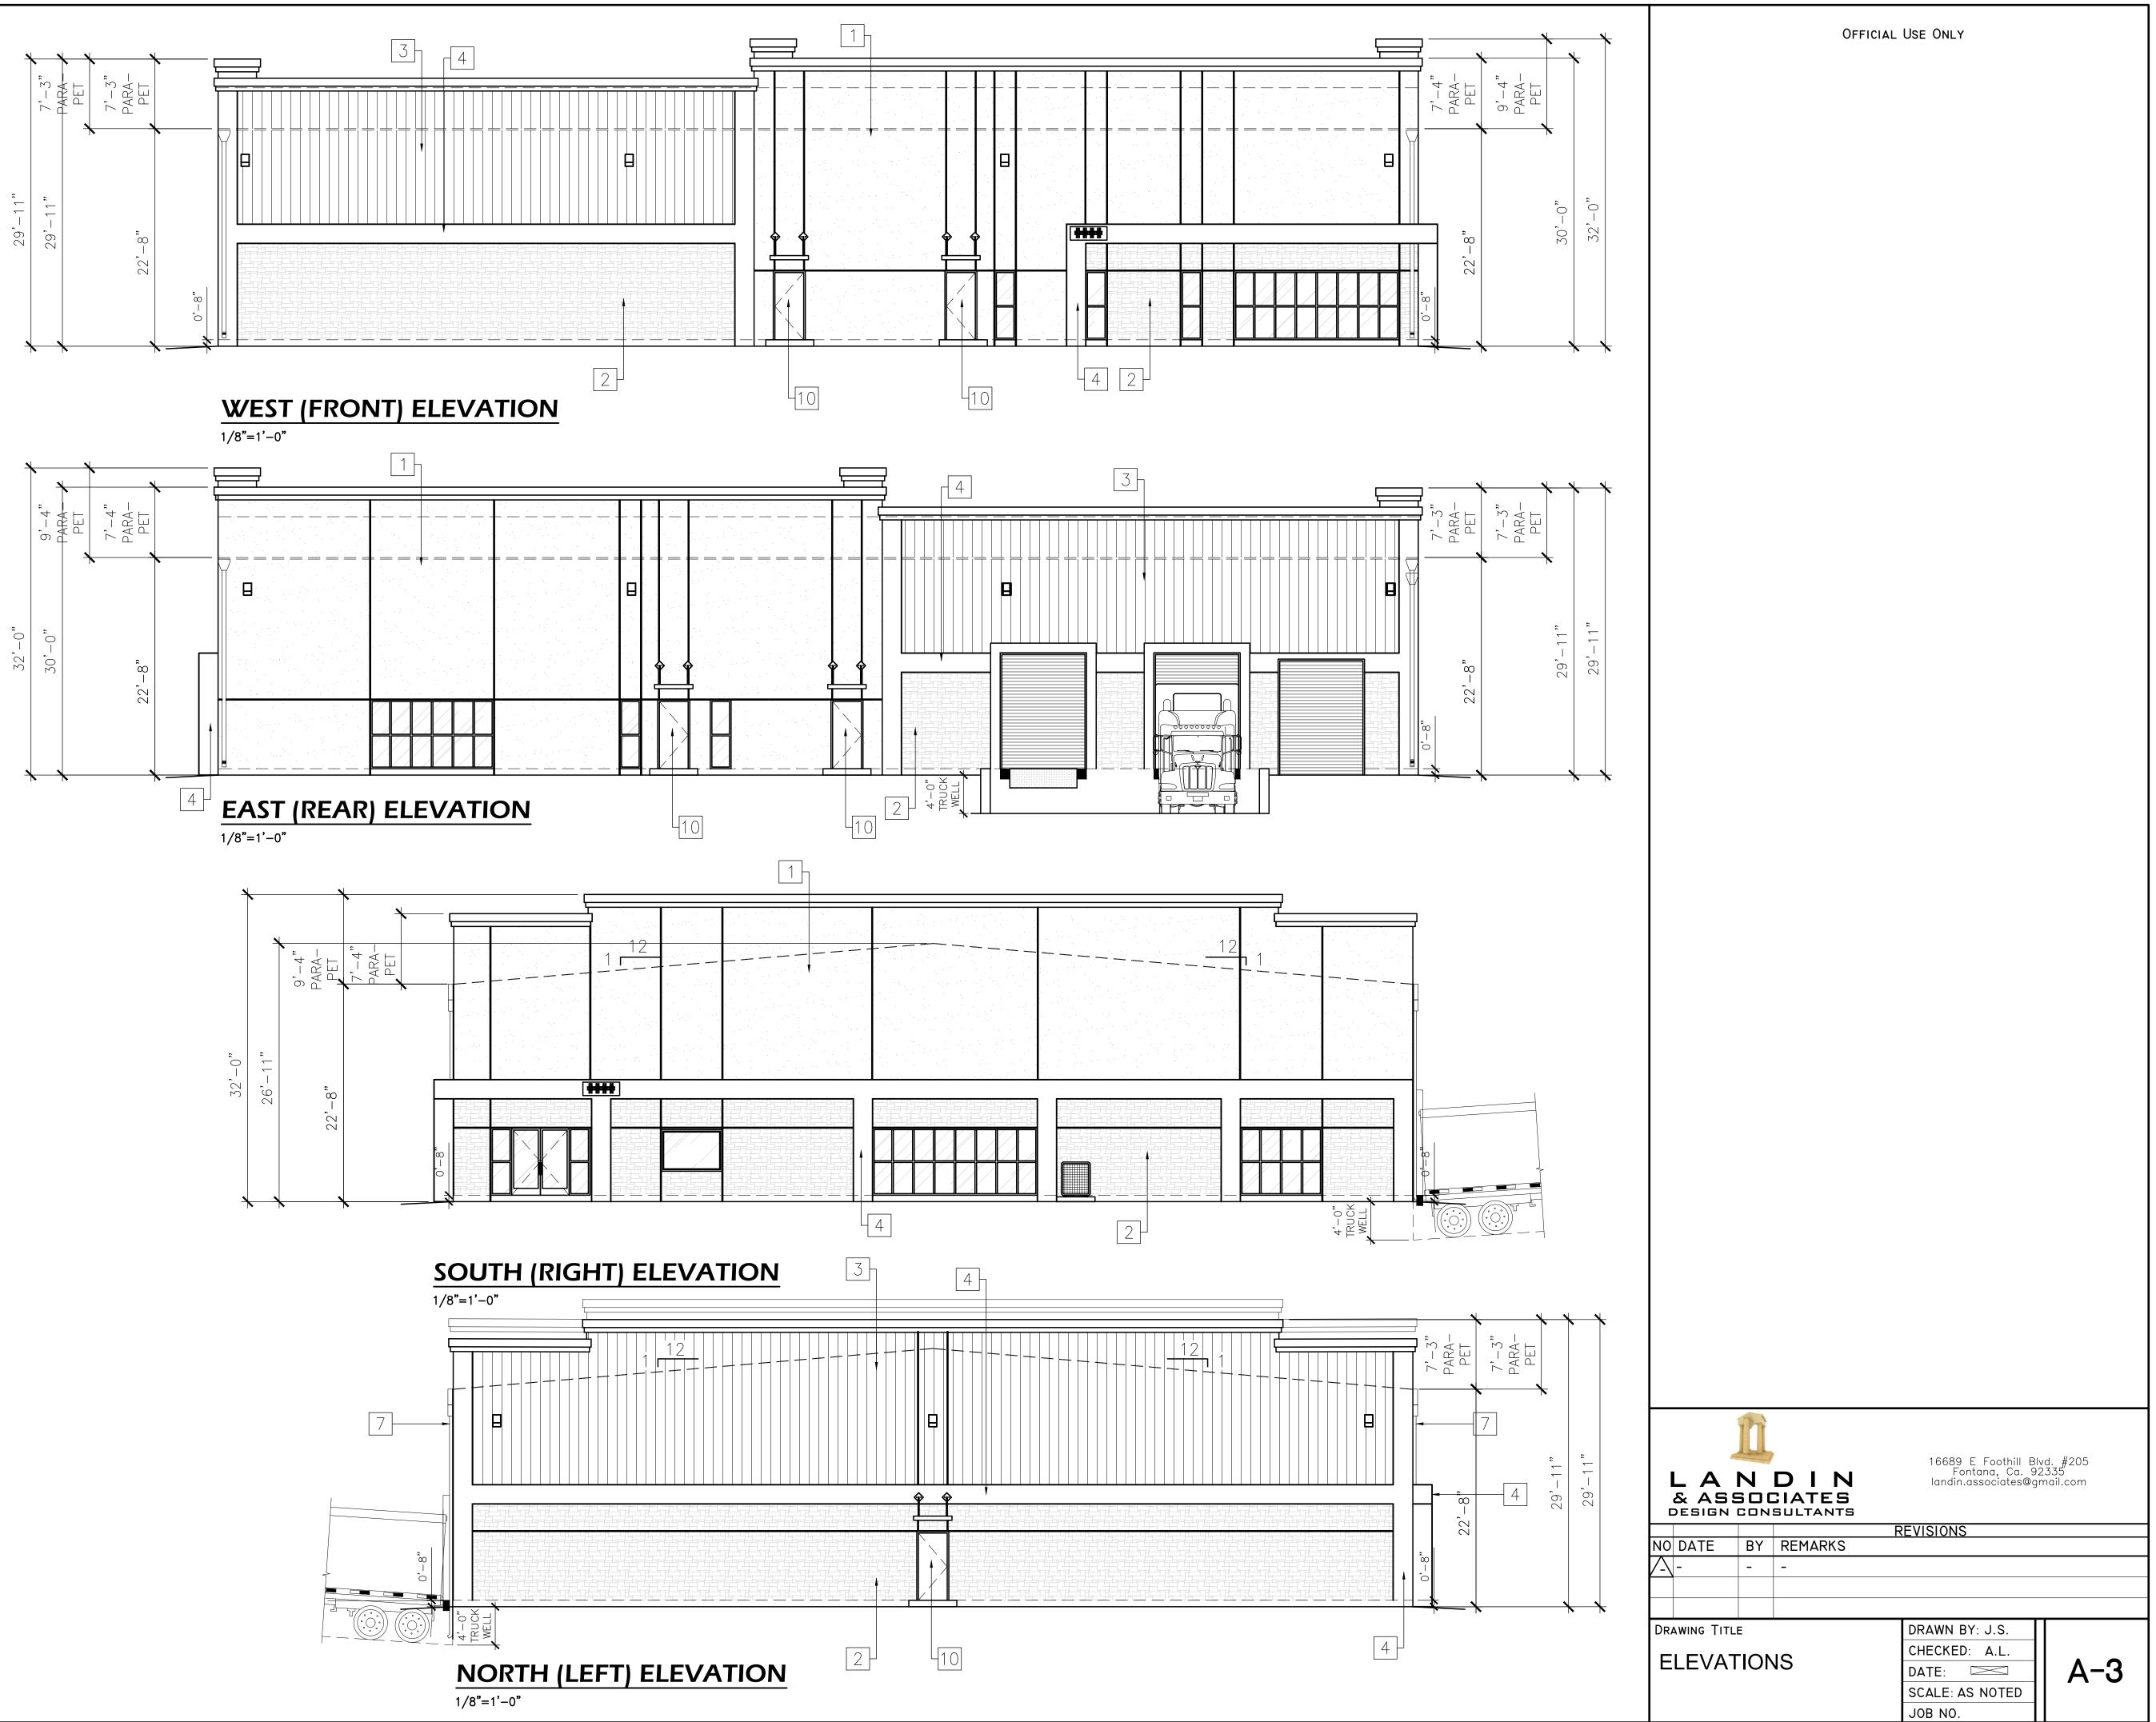

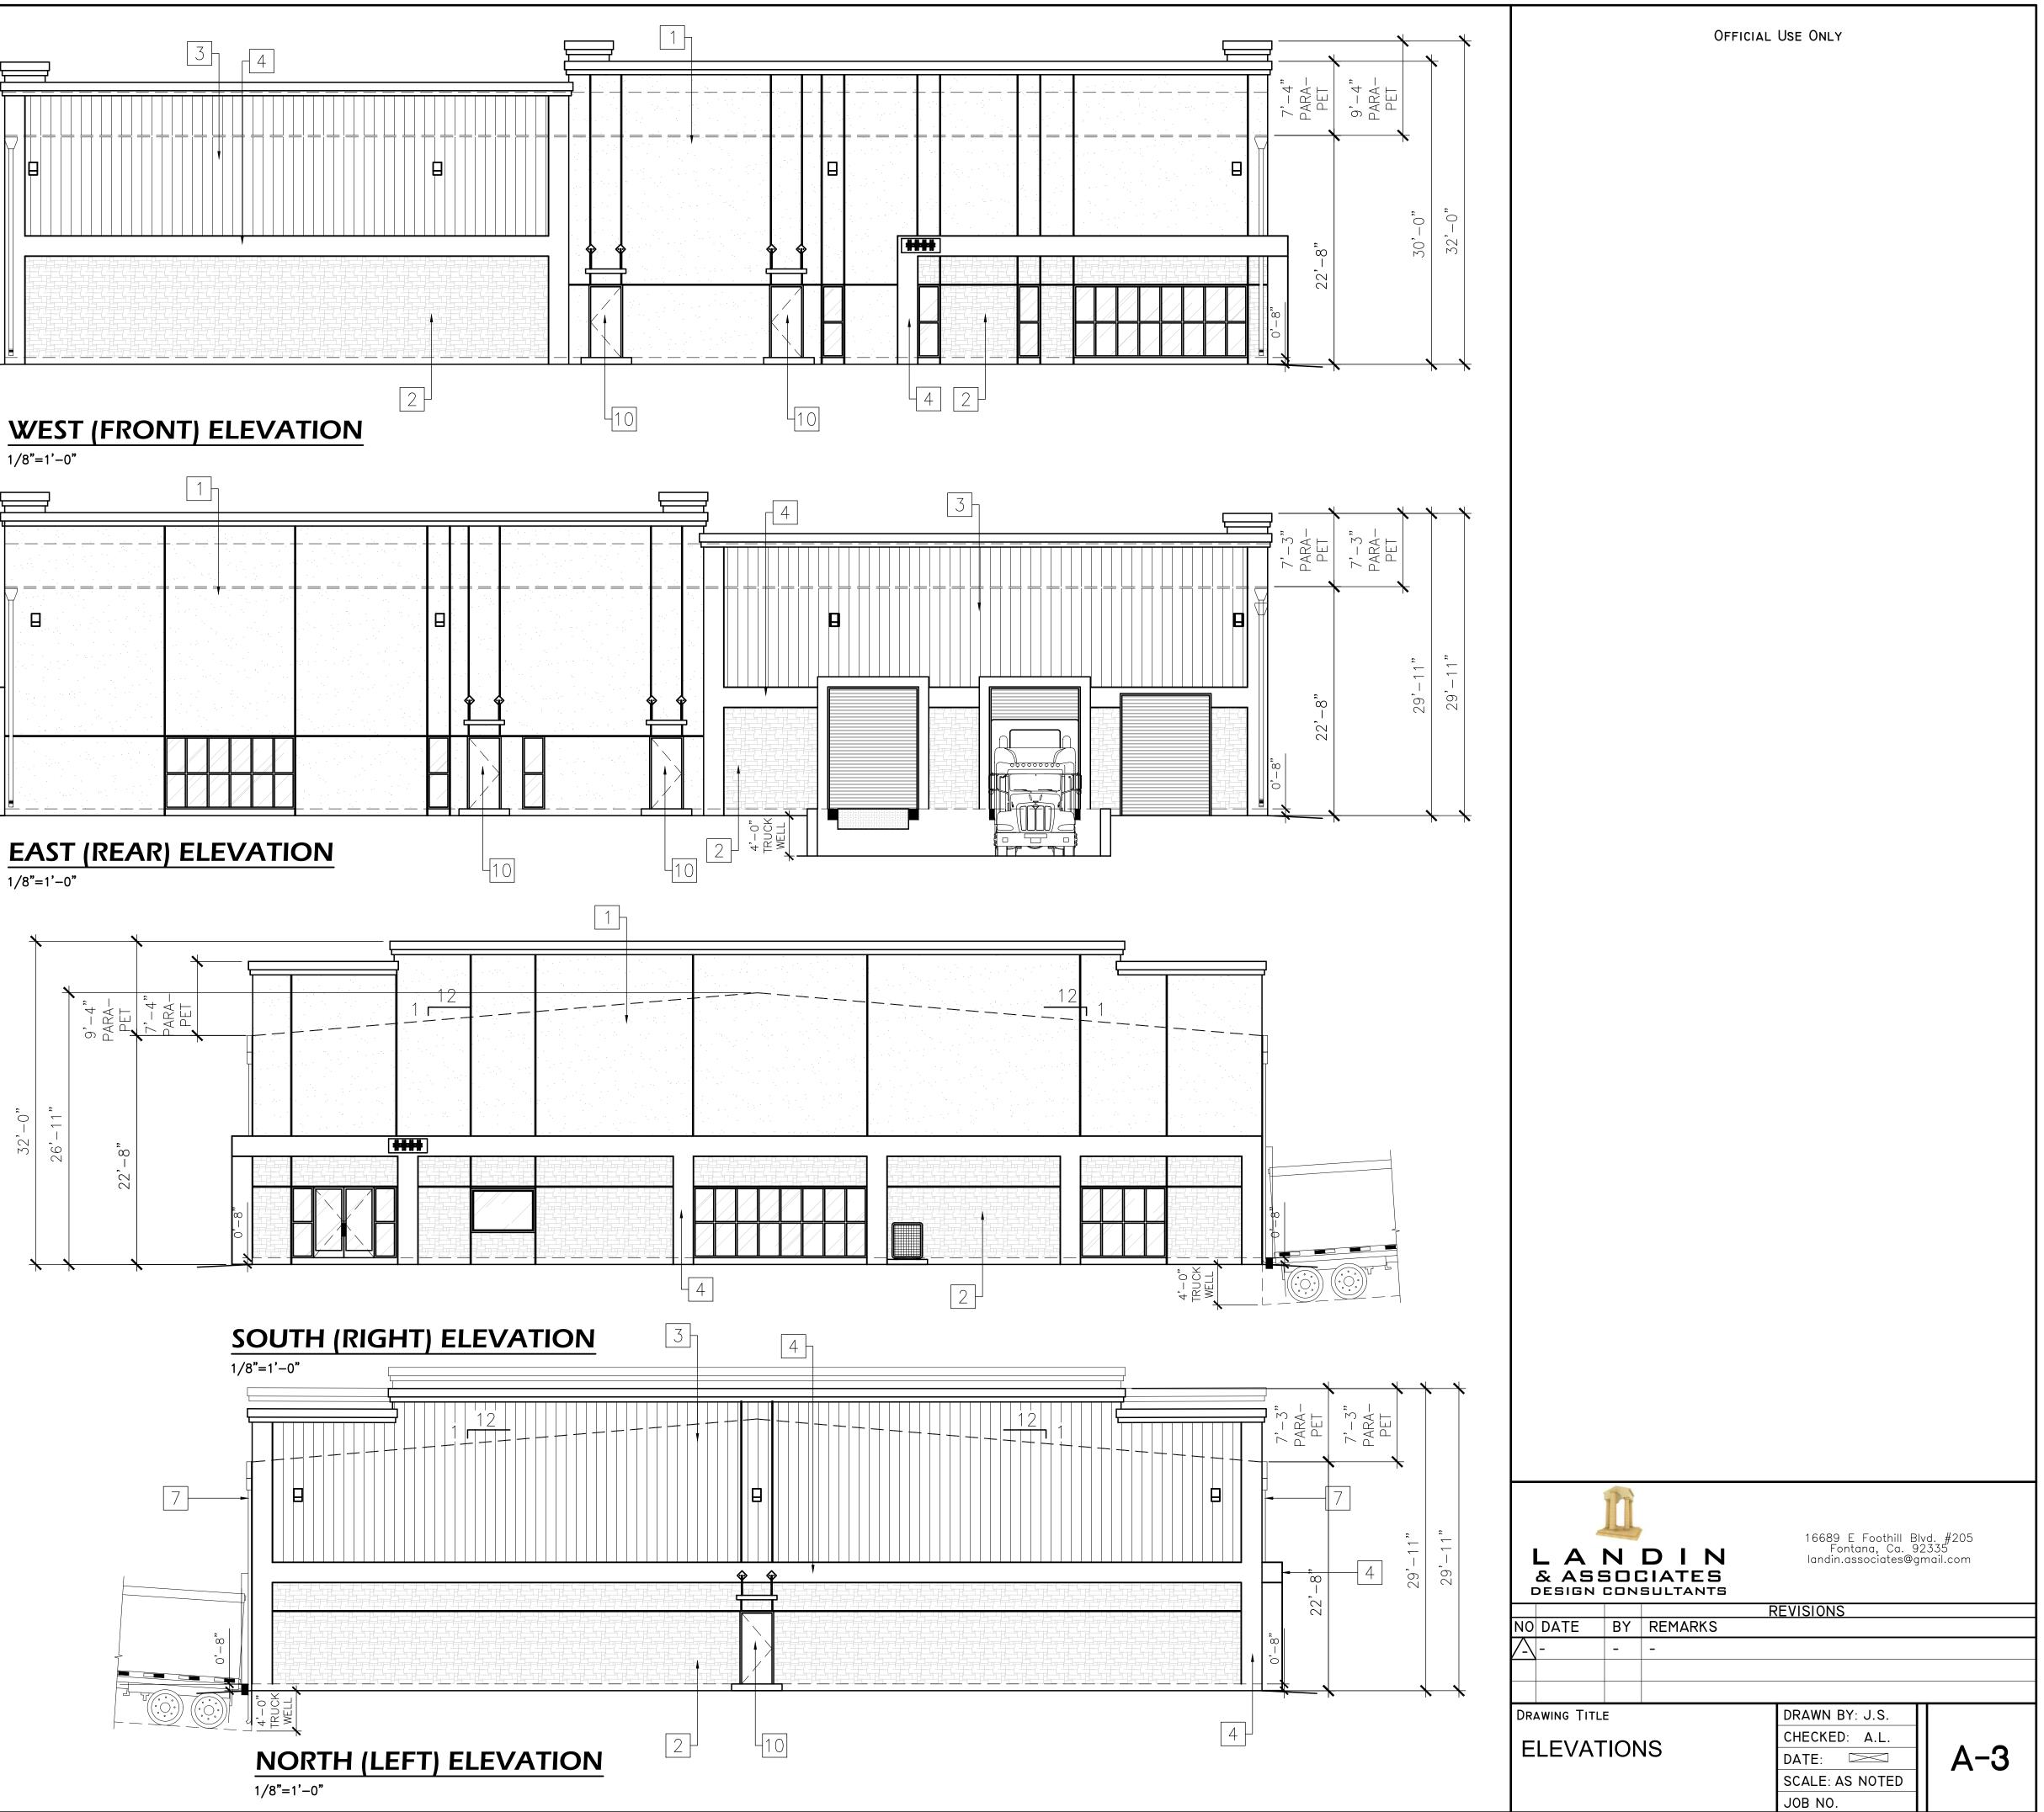

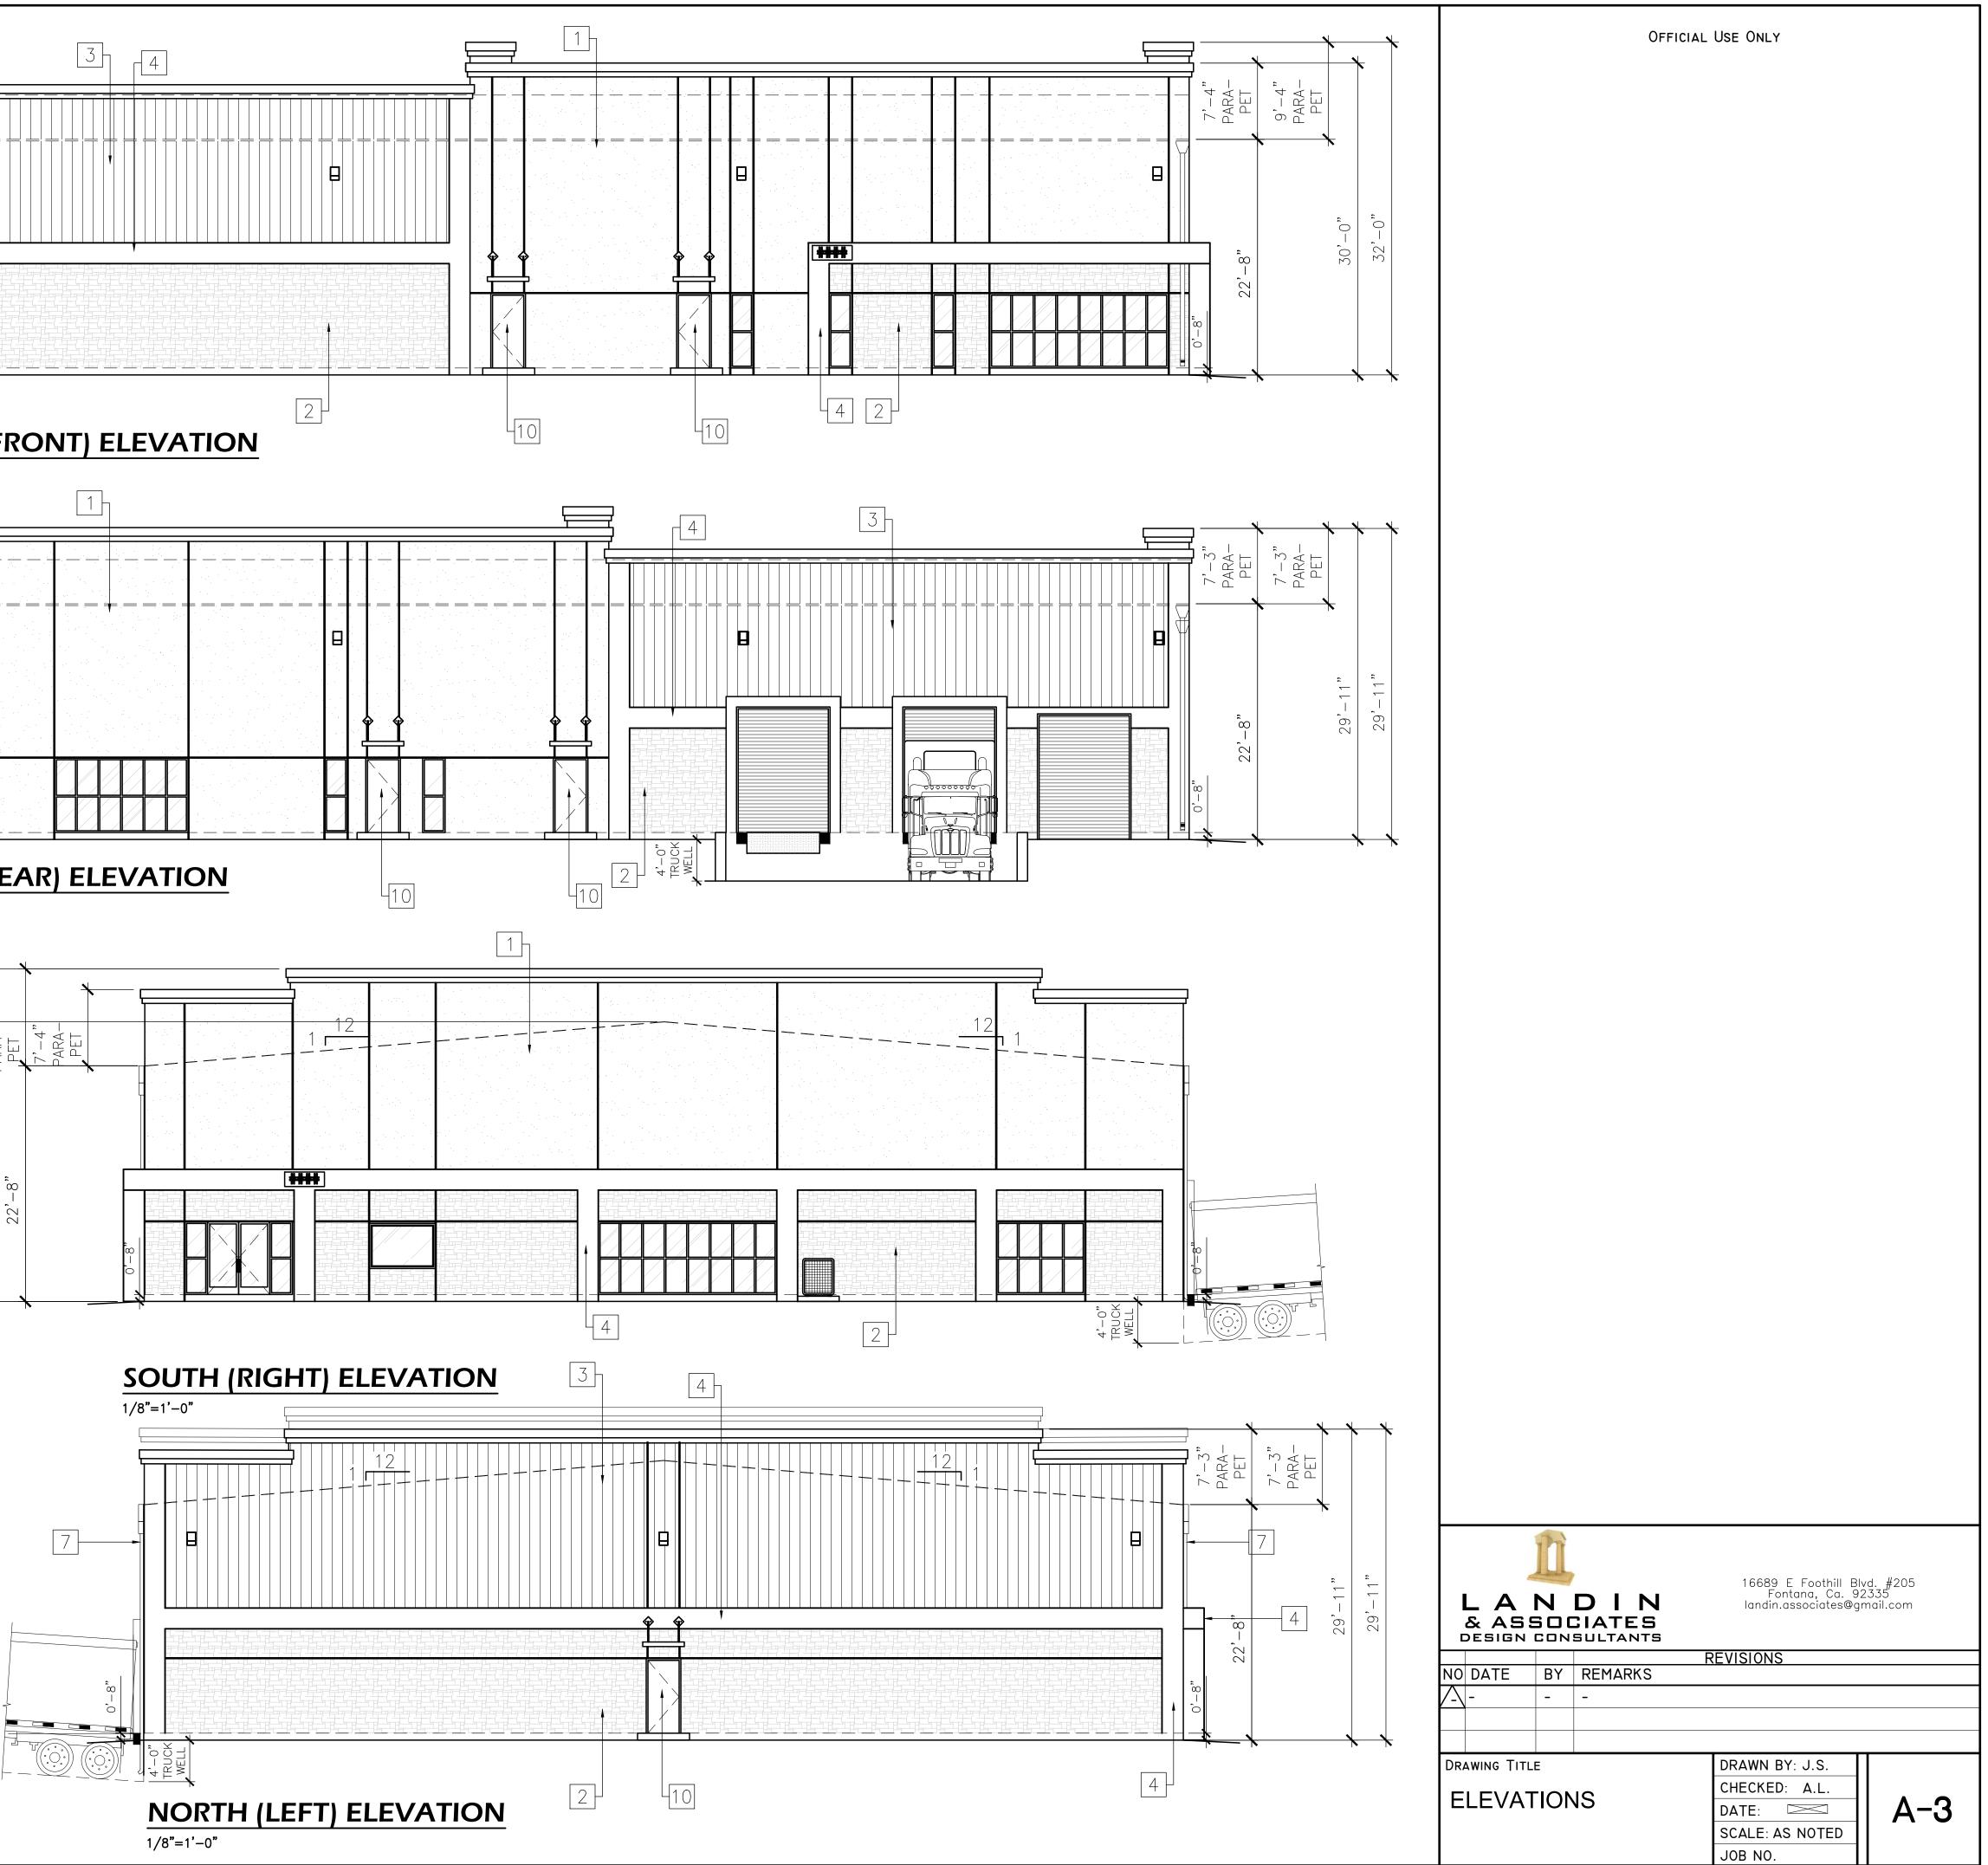

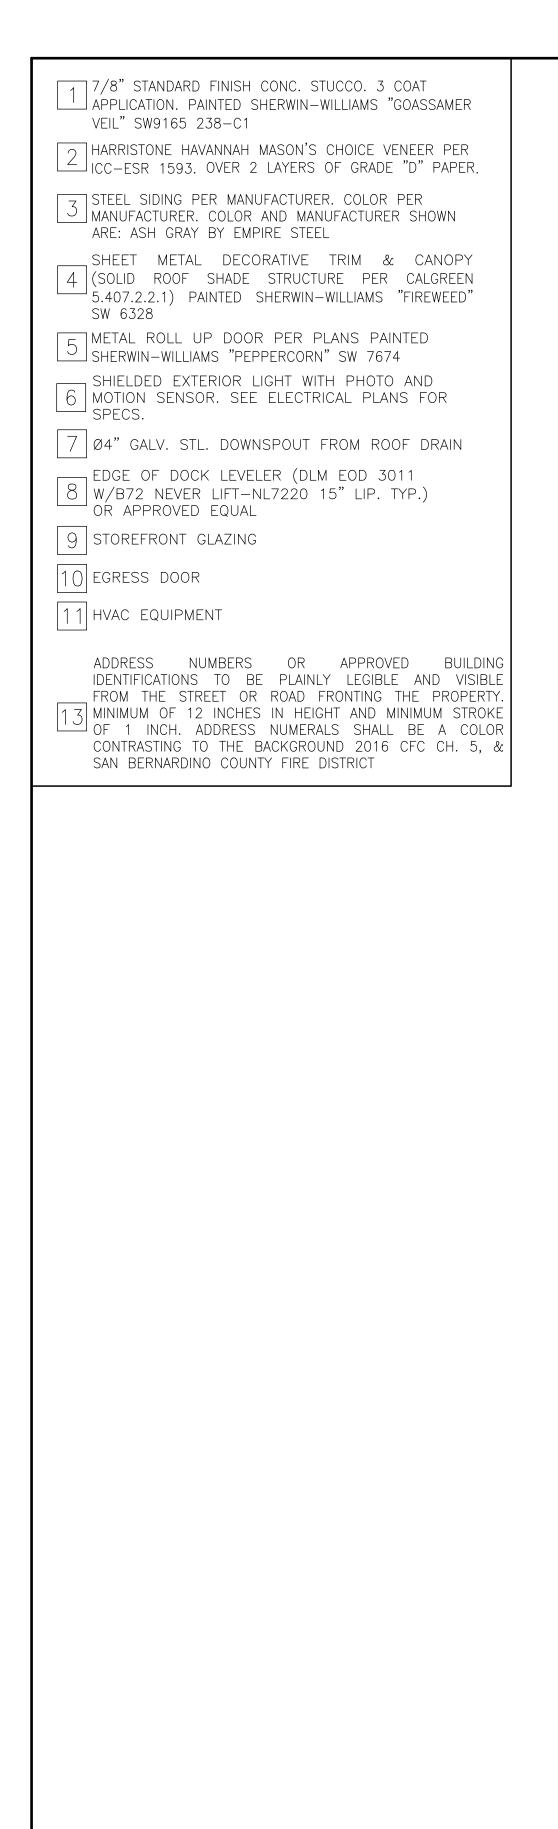

7'-, PAR/ PE





